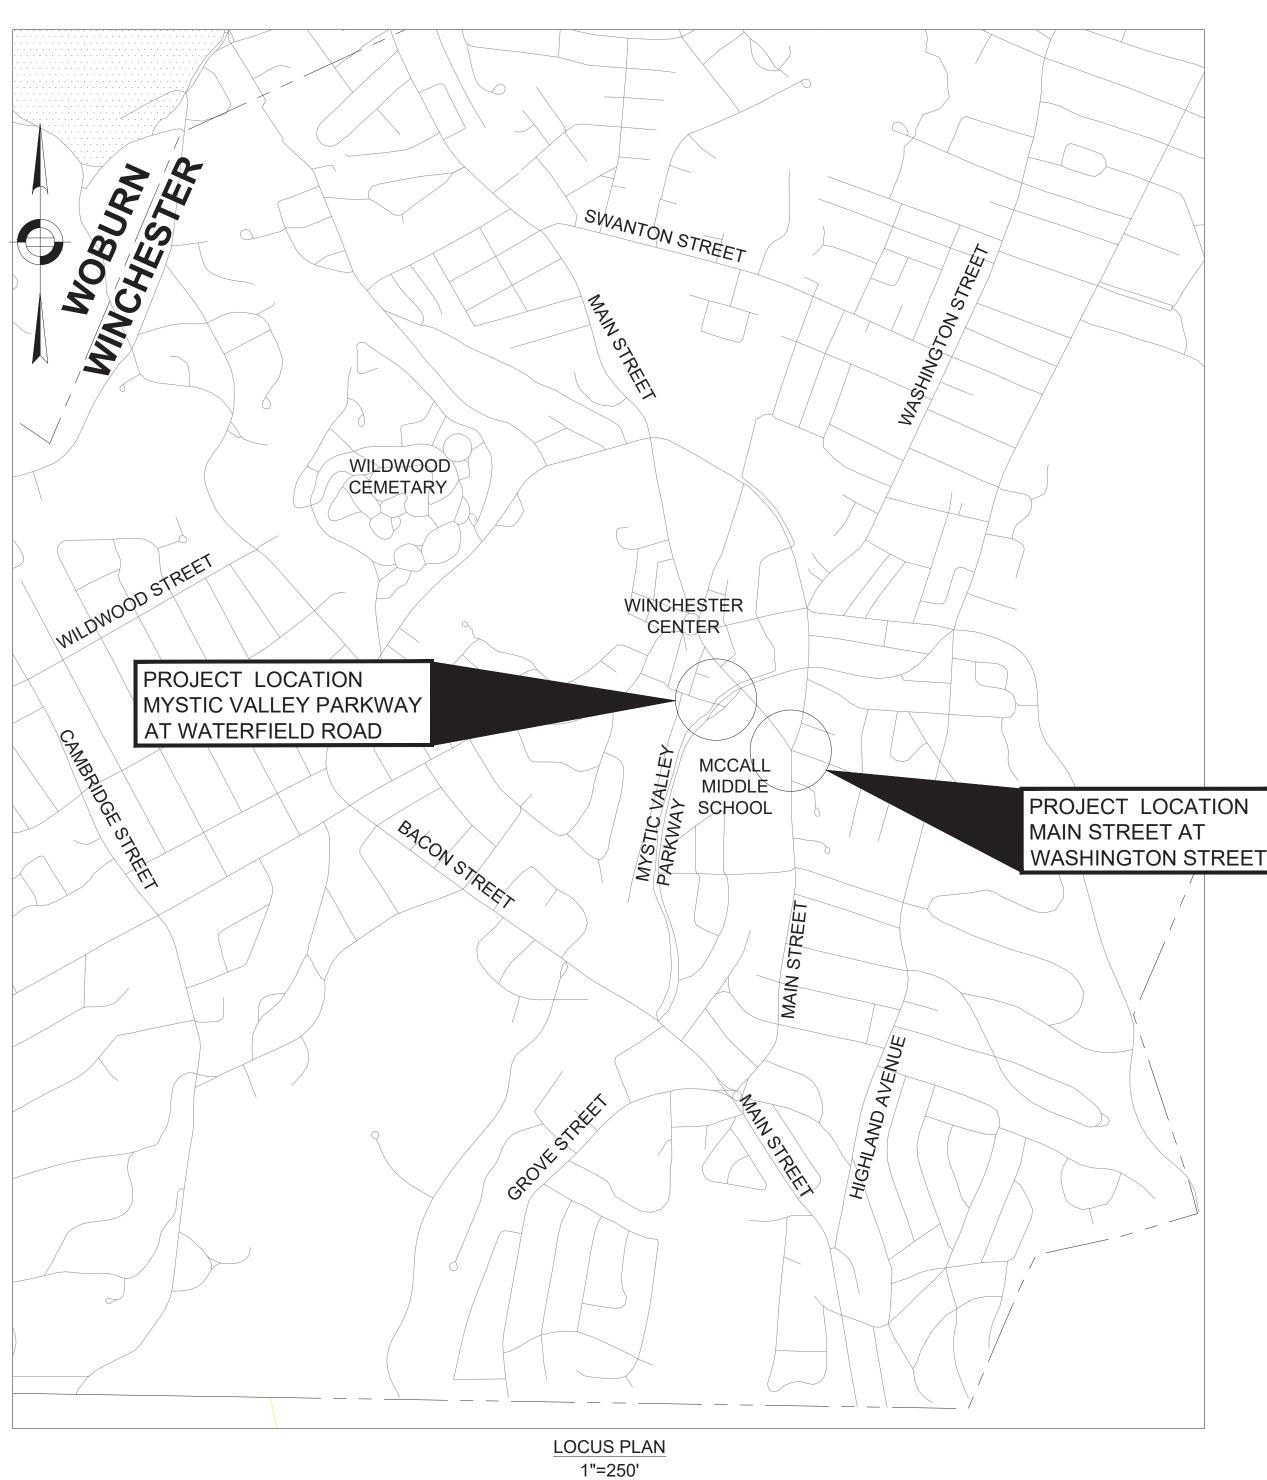
TOWN OF WINCHESTER ROADWAY IMPROVEMENTS

MCCALL MIDDLE SCHOOL EXPANSION



ALL WORK SHALL CONFORM TO THESE PLANS, THE MASSACHUSETTS DEPARTMENT OF TRANSPORTATION (MASSDOT) STANDARD SPECIFICATIONS FOR HIGHWAYS AND BRIDGES DATED 1988, THE MASSDOT SUPPLEMENTAL SPECIFICATIONS DATED JUNE 15, 2012, THE MASSDOT INTERIM SUPPLEMENTAL SPECIFICATIONS DATE OCTOBER 17, 2014, THE MASSDOT 2016 CONSTRUCTION STANDARD DETAILS, THE MASSDOT 1968 STANDARD DRAWINGS FOR TRAFFIC SIGNALS AND HIGHWAY LIGHTING, THE MANUAL ON UNIFORM TRAFFIC CONTROL DEVICES FOR STREETS AND HIGHWAYS, 2009 EDITION, AND ALL INTERIM REVISIONS PUBLISHED BY FEDERAL HIGHWAY ADMINISTRATION.

PROFESSIONAL CERTIFICATION

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ME, AND THAT I AM A DULY LICENSED
PROFESSIONAL ENGINEER UNDER THE
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MASSACHUSETTS,
LICENSE NO. 49208,
EXPIRATION DATE:6/30/2020.



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MCCALL MIDDLE SCHOOL
TRAFFIC IMPROVEMENT PROJECT

FINAL DESIGN

GENERAL SYMBOLS TRAFFIC SYMBOLS ABBREVIATIONS (cont.) **ABBREVIATIONS DESCRIPTION EXISTING** PROPOSED **GENERAL** GENERAL **DESCRIPTION PROPOSED EXISTING** CB CATCH BASIN ANNUAL AVERAGE DAILY TRAFFIC **AADT** NO. NUMBER **CATCH BASIN CURB INLET** *Ø*1 CONTROLLER PHASE ACTUATED PC **ABAN ABANDON** POINT OF CURVATURE **FLAG POLE** PCC A.C. **ASPHALT CONCRETE** POINT OF COMPOUND CURVATURE G GP **GAS PUMP** TRAFFIC SIGNAL HEAD (SIZE AS NOTED) PROFILE GRADE LINE ACCM PIPE ASPHALT COATED CORRUGATED METAL PIPE P.G.L. MAIL BOX \square MB **ADJUST** POINT OF INTERSECTION ADJ **POST SQUARE** WIRE LOOP DETECTOR (6' x 6' TYP UNLESS OTHERWISE SPECIFIED) APPROX. **APPROXIMATE** POC POINT ON CURVE POST CIRCULAR \bigcirc POT BC **BOTTOM OF CURB** POINT ON TANGENT **VIDEO DETECTION CAMERA** \oplus WELL WELL PRC POINT OF REVERSE CURVATURE BD. BOUND EHH **ELECTRIC HANDHOLE** MICROWAVE DETECTOR PROJ PROJECT BIT. **BITUMINOUS** FENCE GATE POST PROP PROPOSED BASELINE BL PEDESTRIAN PUSH BUTTON, SIGN (DIRECTIONAL ARROW AS SHOWN) AND SADDLE O GG **GAS GATE** PSB PLANTABLE SOIL BORROW **BLDG BUILDING** BHL# **BORING HOLE** BHL # **EMERGENCY PREEMPTION CONFIRMATION STROBE LIGHT** PT POINT OF TANGENCY BM **BENCHMARK** → MW # MONITORING WELL PVC POINT OF VERTICAL CURVATURE ВО BY OTHERS VEHICULAR SIGNAL HEAD ■ TP# TEST PIT TP # PVI POINT OF VERTICAL INTERSECTION **BOS BOTTOM OF SLOPE** VEHICULAR SIGNAL HEAD, OPTICALLY PROGRAMMED **HYDRANT ← PVMT** PAVEMENT BR. BRIDGE LIGHT POLE PVT FLASHING BEACON POINT OF VERTICAL TANGENCY СВ **CATCH BASIN COUNTY BOUND PWW** PAVED WATER WAY **CBCI** CATCH BASIN WITH CURB INLET PEDESTRIAN SIGNAL HEAD, (TYPE AS NOTED OR AS SPECIFIED) **GPS POINT** RADIUS OF CURVATURE CC **CEMENT CONCRETE** CABLE MANHOLE RAILROAD SIGNAL ⋈ RRSG RCP REINFORCED CONCRETE PIPE CCM **CEMENT CONCRETE MASONRY** DRAINAGE MANHOLE R&D REMOVE AND DISPOSE CEM CEMENT SIGNAL POST AND BASE (ALPHA-NUMERIC DESIGNATION NOTED) ELECTRIC MANHOLE RD ROAD CI **CURB INLET** MAST ARM, SHAFT AND BASE (ARM LENGTH AS NOTED) 20' GAS MANHOLE **RDWY ROADWAY** CIP **CAST IRON PIPE** MISC MANHOLE REM REMOVE HIGH MAST POLE OR TOWER CIT **CHANGE IN TYPE** SEWER MANHOLE RET RETAIN CL CENTERLINE SIGN AND POST TELEPHONE MANHOLE **RET WALL RETAINING WALL** CLF **CHAIN LINK FENCE ROW RIGHT OF WAY** WATER MANHOLE \bigcirc SIGN AND POST (2 POSTS) CMP CORRUGATED METAL PIPE MHB MASSACHUSETTS HIGHWAY BOUND R&R REMOVE AND RESET MHB CO. COUNTY ≥ 20′ MAST ARM WITH LUMINAIRE RR MONUMENT RAILROAD CONC CONCRETE R&S STONE BOUND OPTICAL PRE-EMPTION DETECTOR REMOVE AND STACK CONTINUOUS **CONT** RT RIGHT TB TOWN OR CITY BOUND **CONST** CONSTRUCTION CONTROL CABINET, GROUND MOUNTED SB STONE BOUND TRAVERSE OR TRIANGULATION STATION CR GR **CROWN GRADE** CONTROL CABINET, POLE MOUNTED SHLD SHOULDER TPL or GUY TROLLEY POLE OR GUY POLE CSP **CORRUGATED STEEL PIPE** SHLO STATE HIGHWAY LAYOUT LINE TRANSMISSION POLE FLASHING BEACON CONTROL AND METER PEDESTAL DHV **DESIGN HOURLY VOLUME** SMH SEWER MANHOLE UTILITY POLE W/ FIREBOX -d- UFB DI **DROP INLET** \bowtie LOAD CENTER ASSEMBLY SSD STOPPING SIGHT DISTANCE - UPDL UTILITY POLE WITH DOUBLE LIGHT DIA DIAMETER ST STREET PULL BOX 12"x12" (OR AS NOTED) UTILITY POLE W / 1 LIGHT _⊱ ULT DIP **DUCTILE IRON PIPE** STA **STATION** ⊸ UPL UTILITY POLE DW STEADY DON'T WALK - PORTLAND ORANGE ELECTRIC HANDHOLE 12"x24" (OR AS NOTED) SW SIDEWALK BUSH **DWY DRIVEWAY** TANGENT DISTANCE OF CURVE/TRUCK % = = = = = = TRAFFIC SIGNAL CONDUIT •SIZE & TYPE **TREE** ELEV (or EL.) ELEVATION TAN **TANGENT STUMP EMB EMBANKMENT** TC TOP OF CURB WATER GATE **EDGE OF PAVEMENT** PAVEMENT MARKINGS SYMBOLS **TEMP TEMPORARY** PARKING METER **EXC EXCAVATION** TOS TOP OF SLOPE EXIST (or EX) EXISTING OVERHEAD CABLE/WIRE **PROPOSED** DESCRIPTION **EXISTING** TYP **TYPICAL CURBING** F&C FRAME AND COVER UP **UTILITY POLE** CONTOURS (ON-THE-GROUND SURVEY DATA) PAVEMENT ARROW - WHITE F&G FRAME AND GRATE VAR **VARIES** CONTOURS (PHOTOGRAMMETRIC DATA) FDN. **FOUNDATION** LEGEND "ONLY" - WHITE VC VERTICAL CURVE UNDERGROUND DRAIN PIPE (DOUBLE LINE 24 INCH AND OVER) **FLDSTN FIELDSTONE** VERT **VERTICAL** - UNDERGROUND ELECTRIC DUCT (DOUBLE LINE 24 INCH AND OVER) STOP LINE FYG FLUORESCENT YELLOW- GREEN **VGC VERTICAL GRANITE CURB** - UNDERGROUND GAS MAIN (DOUBLE LINE 24 INCH AND OVER) **GAR** GARAGE CROSSWALK CW **WCR** WHEEL CHAIR RAMP - UNDERGROUND SEWER MAIN (DOUBLE LINE 24 INCH AND OVER) GD GROUND WG WATER GATE SOLID WHITE LINE - UNDERGROUND TELEPHONE DUCT (DOUBLE LINE 24 INCH AND OVER) GG **GAS GATE WIP** WROUGHT IRON PIPE UNDERGROUND WATER MAIN (DOUBLE LINE 24 INCH AND OVER) GI SOLID YELLOW LINE **GUTTER INLET** WM WATER METER/WATER MAIN **GIP** BALANCED STONE WALL GALVANIZED IRON PIPE WSO WATER SHUT OFF VALVE BROKEN WHITE LINE **GRAN GUARD RAIL - STEEL POSTS** GRANITE X-SECT **CROSS SECTION** BROKEN YELLOW LINE **GRAV GUARD RAIL - WOOD POSTS GRAVEL GRD** GUARD CHAIN LINK OR METAL FENCE DOTTED WHITE LINE **HDW HEADWALL** WOOD FENCE __ _ <u>DYL</u> __ _ DOTTED YELLOW LINE **HOT MIX ASPHALT** TREE LINE HOR **HORIZONTAL** SAWCUT LINE DOTTED WHITE LINE EXTENSION HYD **HYDRANT** — TOP OR BOTTOM OF SLOPE ____ DYLEx ____ DOTTED YELLOW LINE EXTENSION INV **INVERT** EDGE OF PAVEMENT JCT **JUNCTION** DOUBLE WHITE LINE -----LIMIT OF MICROMILLING AND OVERLAY LENGTH OF CURVE BANK OF RIVER OR STREAM DOUBLE YELLOW LINE **LEACH BASIN BORDER OF WETLAND** LP LIGHT POLE 100 FT WETLAND BUFFER LT LEFT 200 FT RIVERFRONT BUFFER MAX **MAXIMUM** STATE HIGHWAY LAYOUT MB MAILBOX - TOWN OR CITY LAYOUT MH **MANHOLE** COUNTY LAYOUT MHB MASSACHUSETTS HIGHWAY BOUND TOWN OR CITY BOUNDARY LINE MIN MINIMUM PROPERTY LINE OR APPROXIMATE PROPERTY LINE FINAL DESIGN **NIC NOT IN CONTRACT EASEMENT** REUSE OF DOCUMENTS PROJECT NO. PROFESSIONAL CERTIFICATION 60139 I HEREBY CERTIFY THAT THESE PLANS MCCALL MIDDLE SCHOOL DATE WERE PREPARED OR APPROVED BY TRAFFIC IMPROVEMENT PROJECT 3/18/2020 ME, AND THAT I AM A DULY LICENSED PROFESSIONAL ENGINEER UNDER THE DRAWING NO. FAX: 301.927.2800

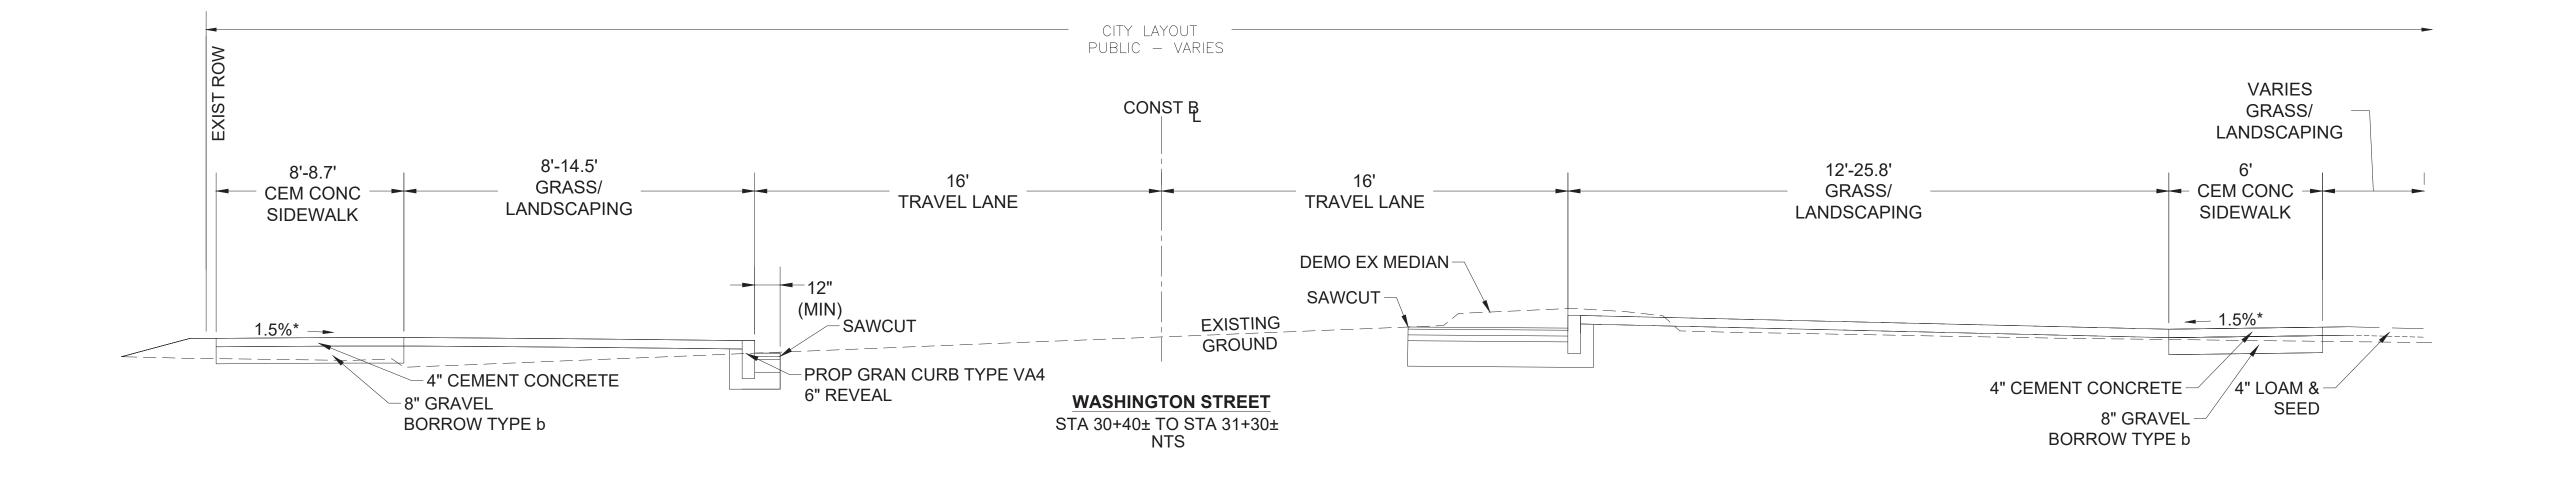
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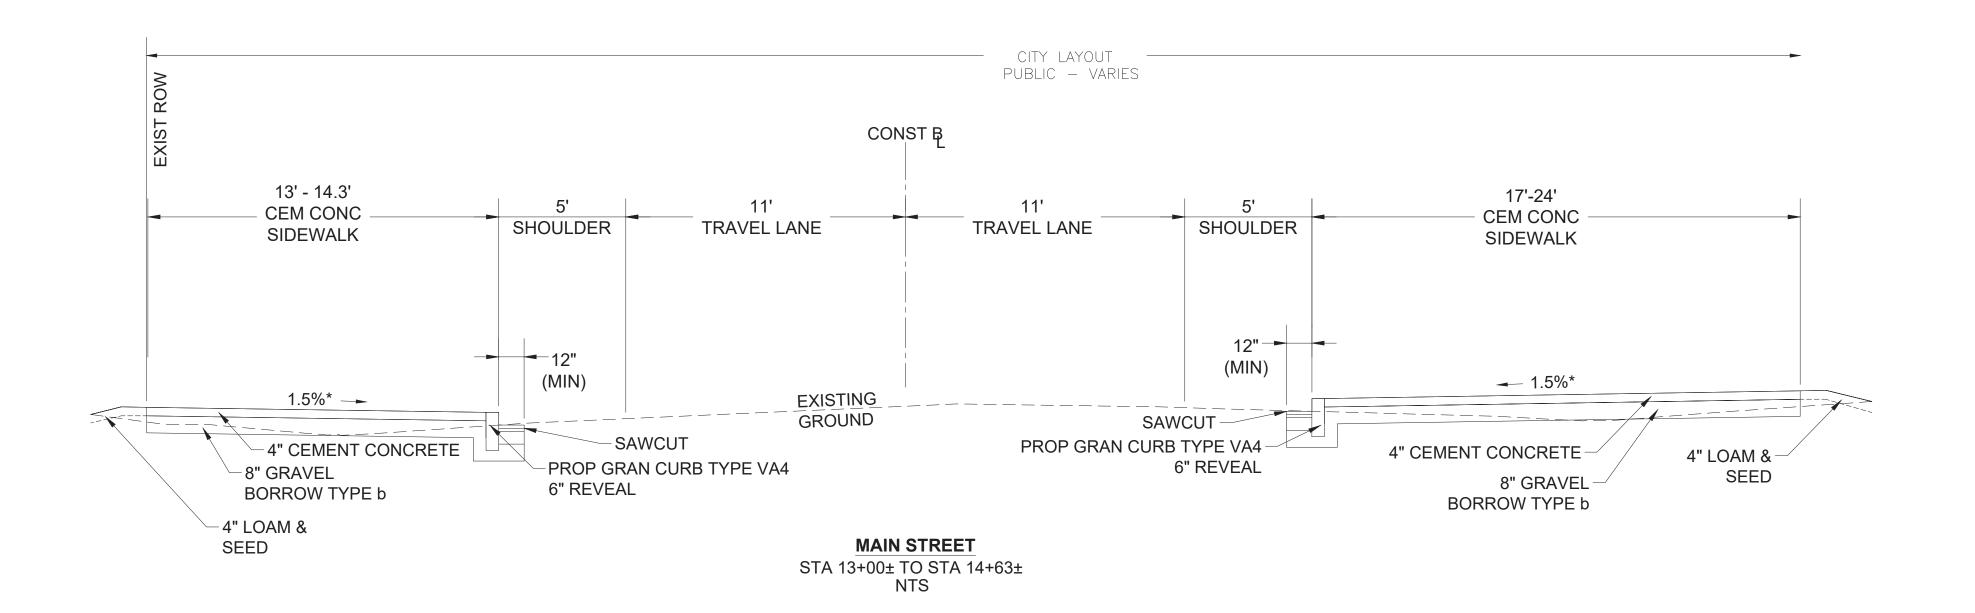



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	DSGN	CBK					
SETTS	DR	RPI					
5/F	CHK	KMF					
	APVD	ELG	NO.	DATE	REVISION	BY	APVD



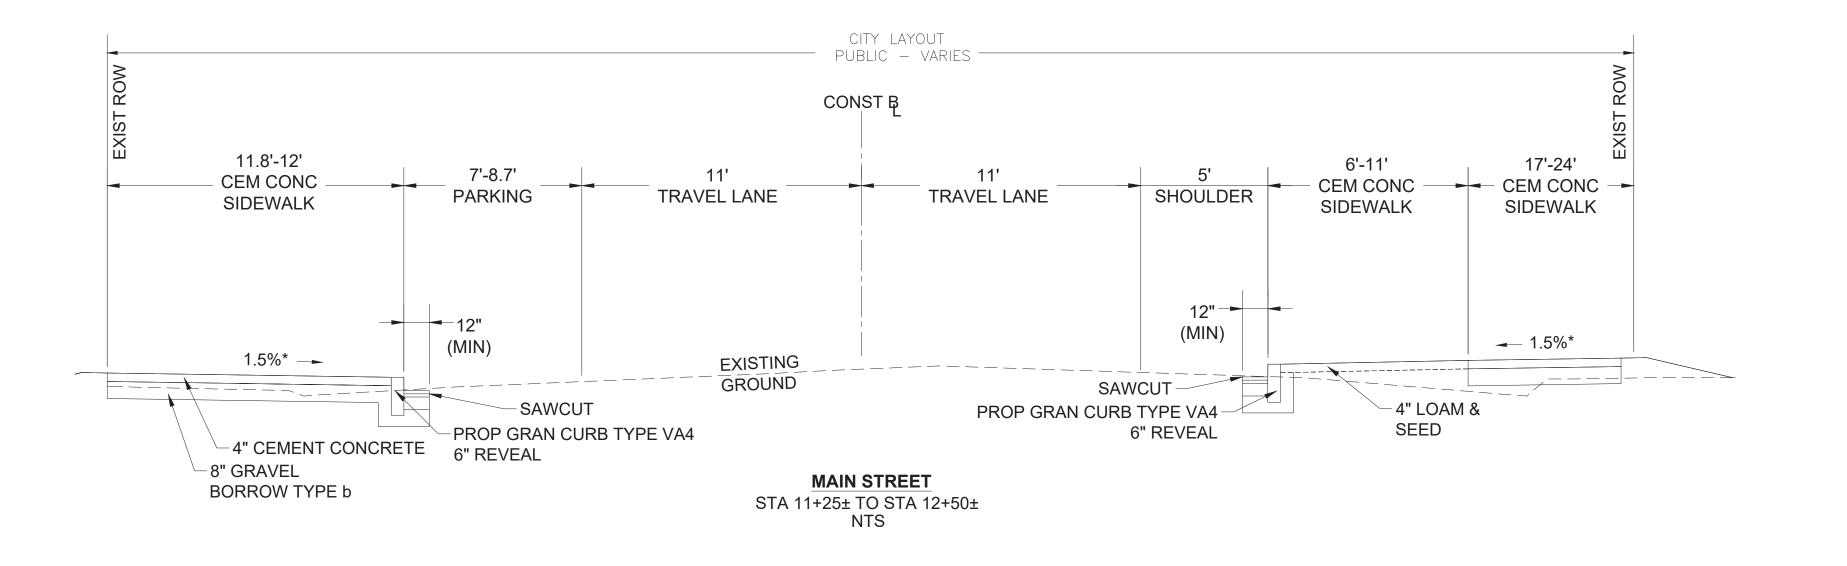LEGEND & ABBREVIATIONS G.02 SHEET NO. 2 OF 39







PAVEMENT NOTES:

CEMENT CONCRETE SIDEWALK/WHEELCHAIR RAMP

4" CEMENT CONCRETE (4000 PSI, 3/4", 610, AIR-ENTRAINED)

BASE: 8" GRAVEL BORROW TYPE b

CEMENT CONCRETE DRIVEWAY SURFACE:

6" CEMENT CONCRETE

(4000 PSI, 3/4", 610, AIR-ENTRAINED)

BASE: 8" GRAVEL BORROW TYPE B

HOT MIX ASPHALT (HMA) SIDEWALK/DRIVEWAY

1.5" SUPERPAVE SURFACE COURSE 9.5 (SSC-9.5) OVER 2.0" SUPERPAVE INTERMEDIATE COURSE 12.5 (SIC-12.5)

8" GRAVEL BORROW TYPE b

MILLING & OVERLAY SURFACE COURSE SURFACE: 1.5" SUPERPAVE SURFACE COURSE (SSC-9.5)

PAVEMENT MILLING 1.5" MICROMILLING

BRICK SIDEWALK

SUB-BASE

BASE:

SURFACE: BRICK PAVER (MATCH EXISTING)

3/4" SAND ASPHALT SETTING BED

4" SUPERPAVE INTERMEDIATE COURSE 12.5 (SIC-12.5) BASE:

SUB-BASE: 6" GRAVEL BORROW TYPE b

FULL DEPTH PAVEMENT CONSTRUCTION

1.0" SUPERPAVE SURFACE COURSE 9.5 (SSC-9.5) OVER

5.50" SUPERPAVE INTERMEDIATE COURSE 19.0 (SIC-19.0)

(2 - 2.75" LIFTS) OVER

BASE: 12" GRAVEL BORROW TYPE b

FULL DEPTH PAVEMENT CONSTRUCTION (<4' WIDE)

1.5" SUPERPAVE SURFACE COURSE 9.5 (SSC-9.5) OVER 1.5" SUPERPAVE INTERMEDIATE COURSE 9.5 (SIC-9.5)

BASE: 6" CEMENT CONCRETE BASE COURSE OVER

(HIGH EARLY STRENGTH)

8" GRAVEL BORROW TYPE b

(SEE GENERAL PAVEMENT NOTE 1)

FINAL DESIGN

60139

3/18/2020


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3 OF 39
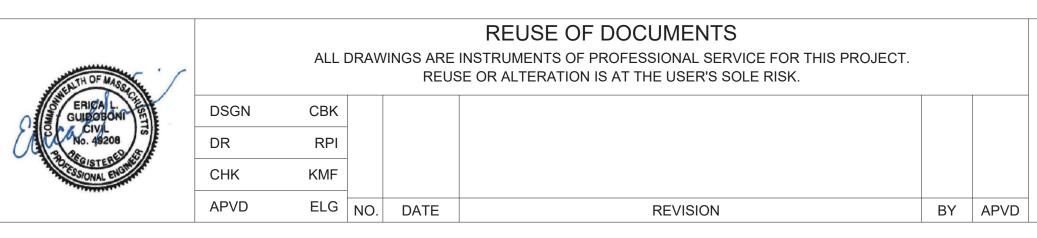
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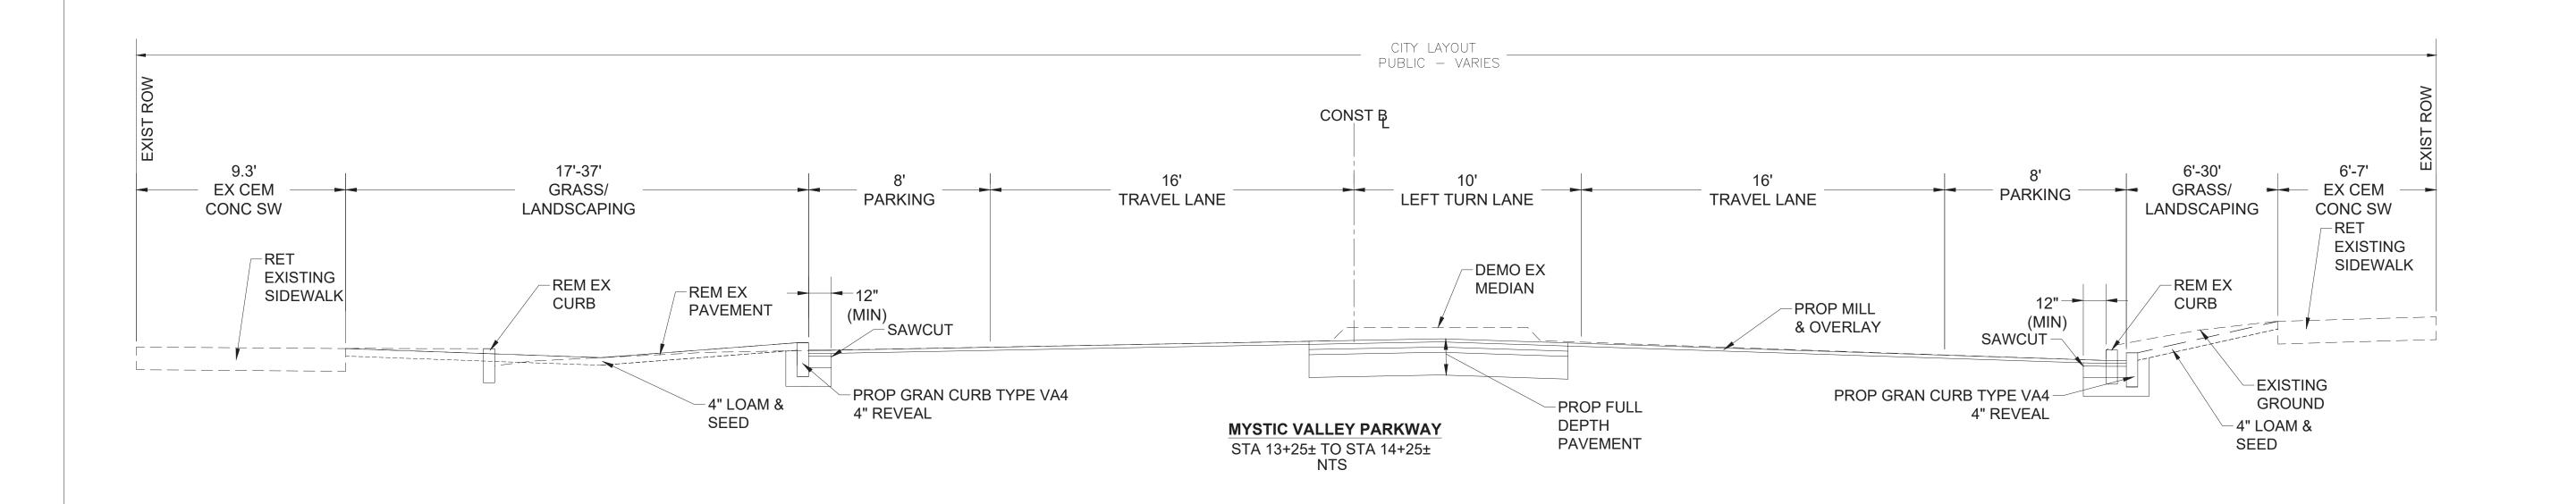
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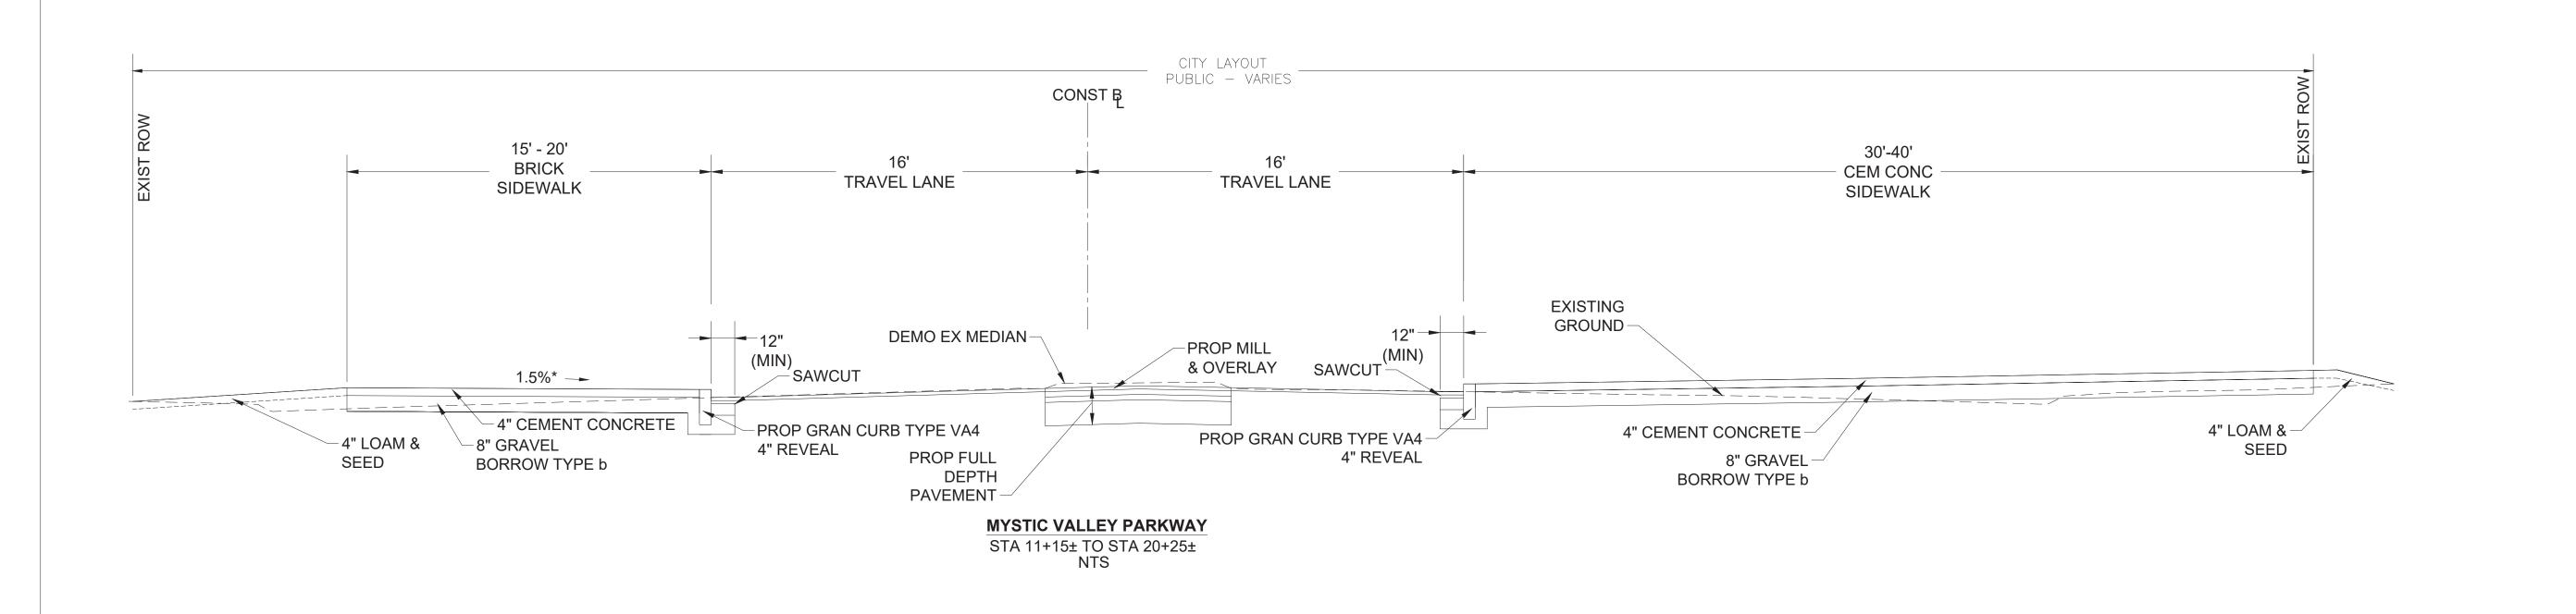


	2 OLIVER STREET, SUITE 305
	BOSTON, MA 02109
	PHONE: 617.619.9910
	FAX: 301.927.2800
DESIGN	www.tooledesign.com

MCCALL MIDDLE SCHOOL TRAFFIC IMPROVEMENT PROJECT

	DATE
MAIN STREET AT WASHINGTON STREET TYPICAL SECTIONS	DRAWING NO.
	SHEET NO.

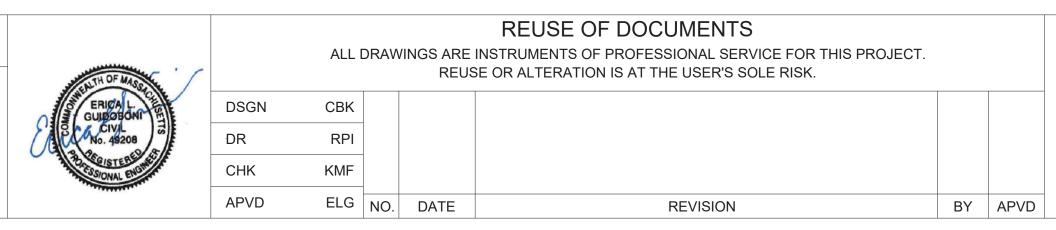




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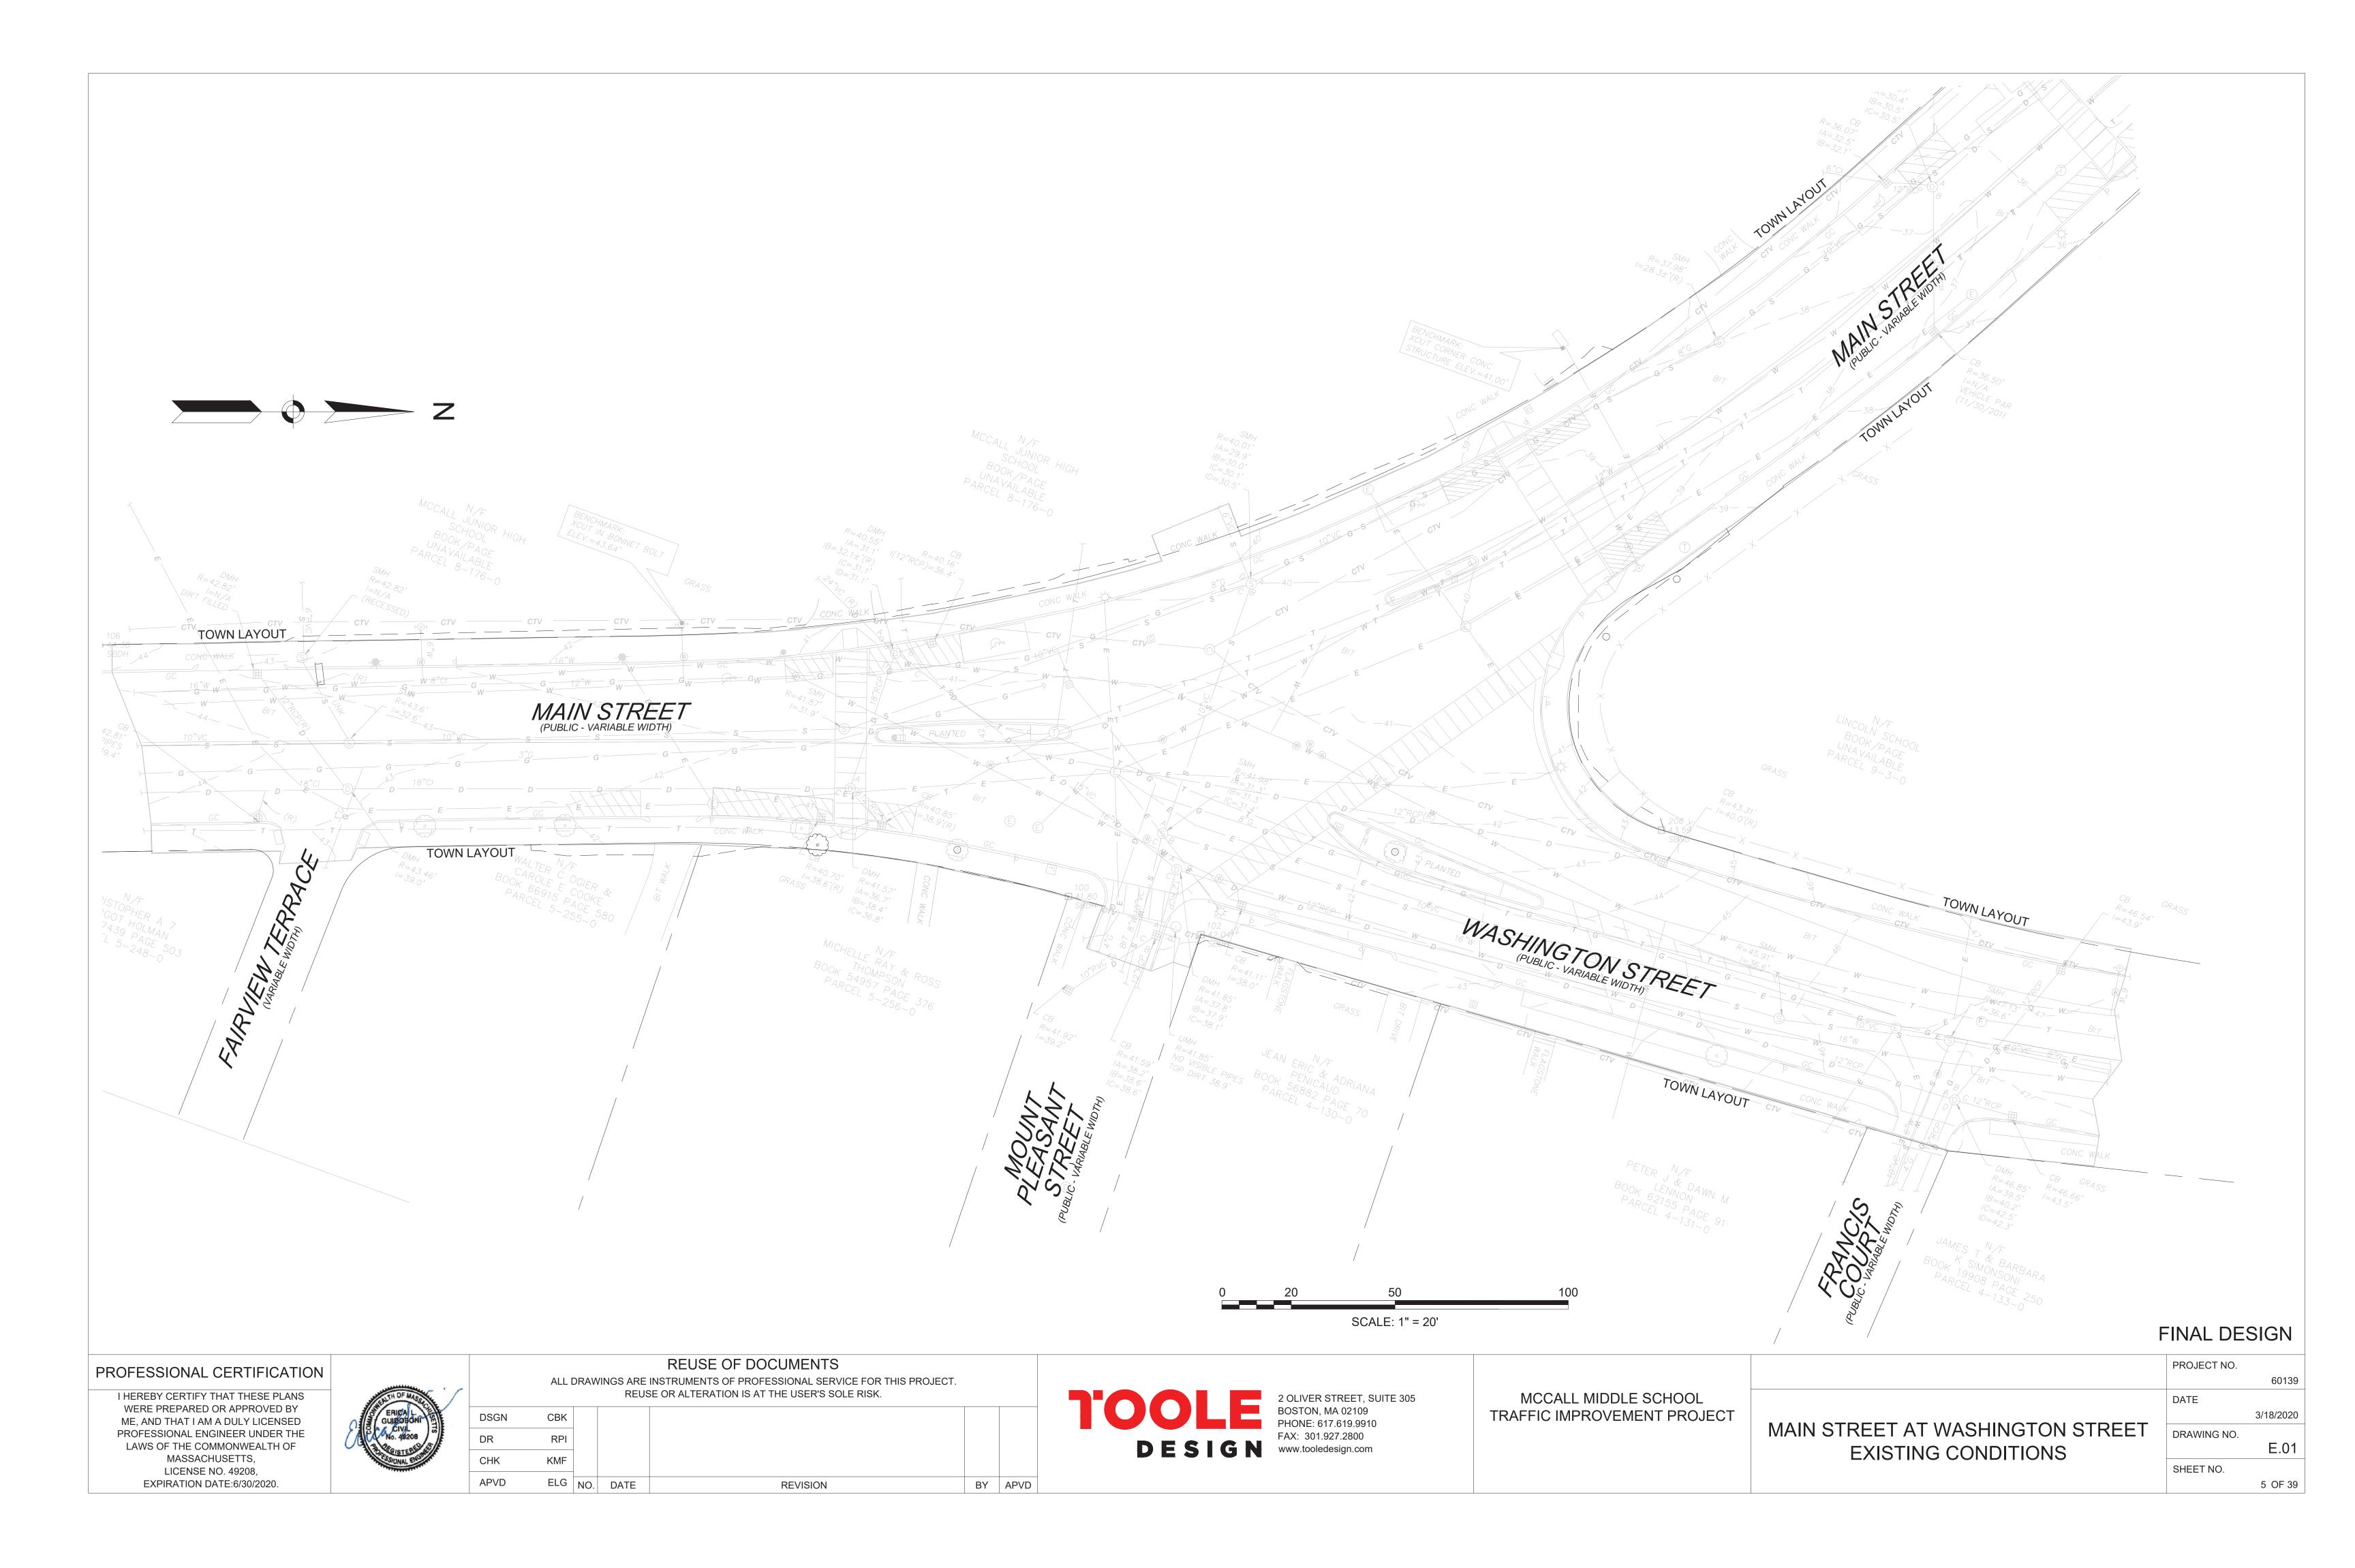
PROFESSIONAL CERTIFICATION


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IOOLE	BOSTON, MA 02109 PHONE: 617.619.9910
DESIGN	FAX: 301.927.2800 www.tooledesign.com

		PROJECT NO.	
			60139
MCCALL MIDDLE SCHOOL		DATE	
TRAFFIC IMPROVEMENT PROJECT			3/18/2020
	MYSTIC VALLEY PARKWAY	DRAWING NO.	
	TYPICAL SECTIONS		TS.02
		SHEET NO.	
			4 OF 39




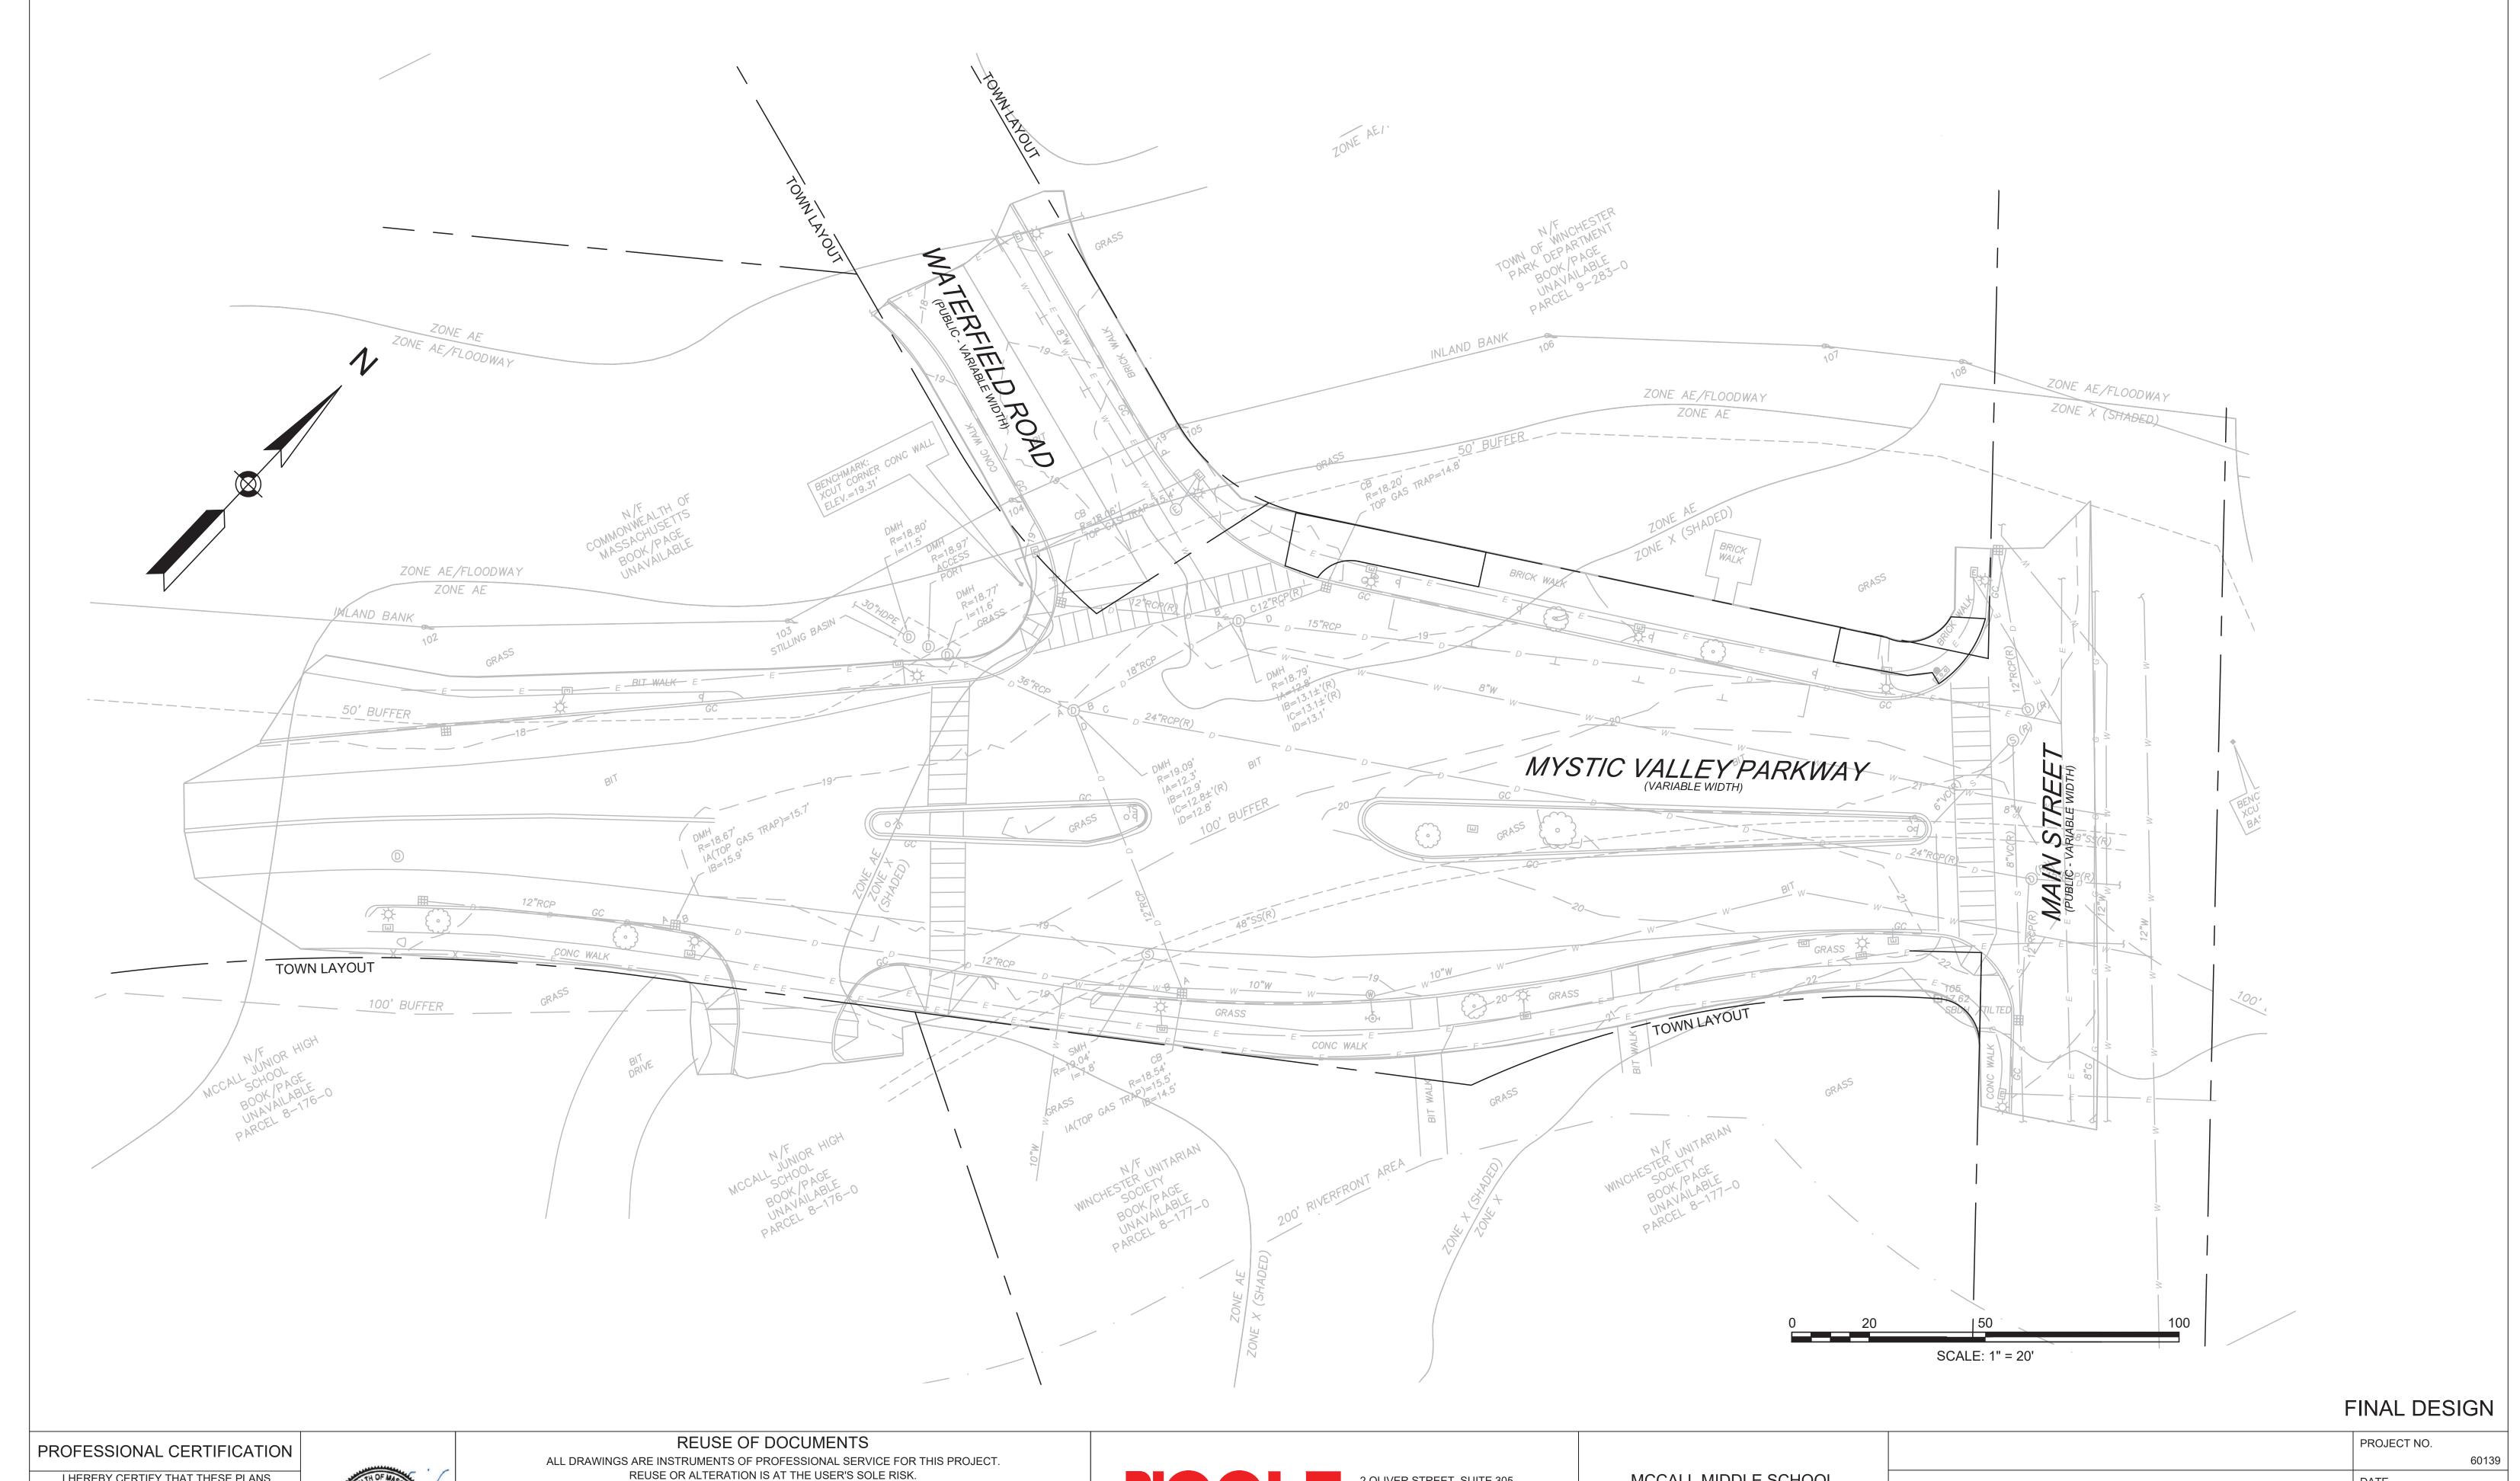
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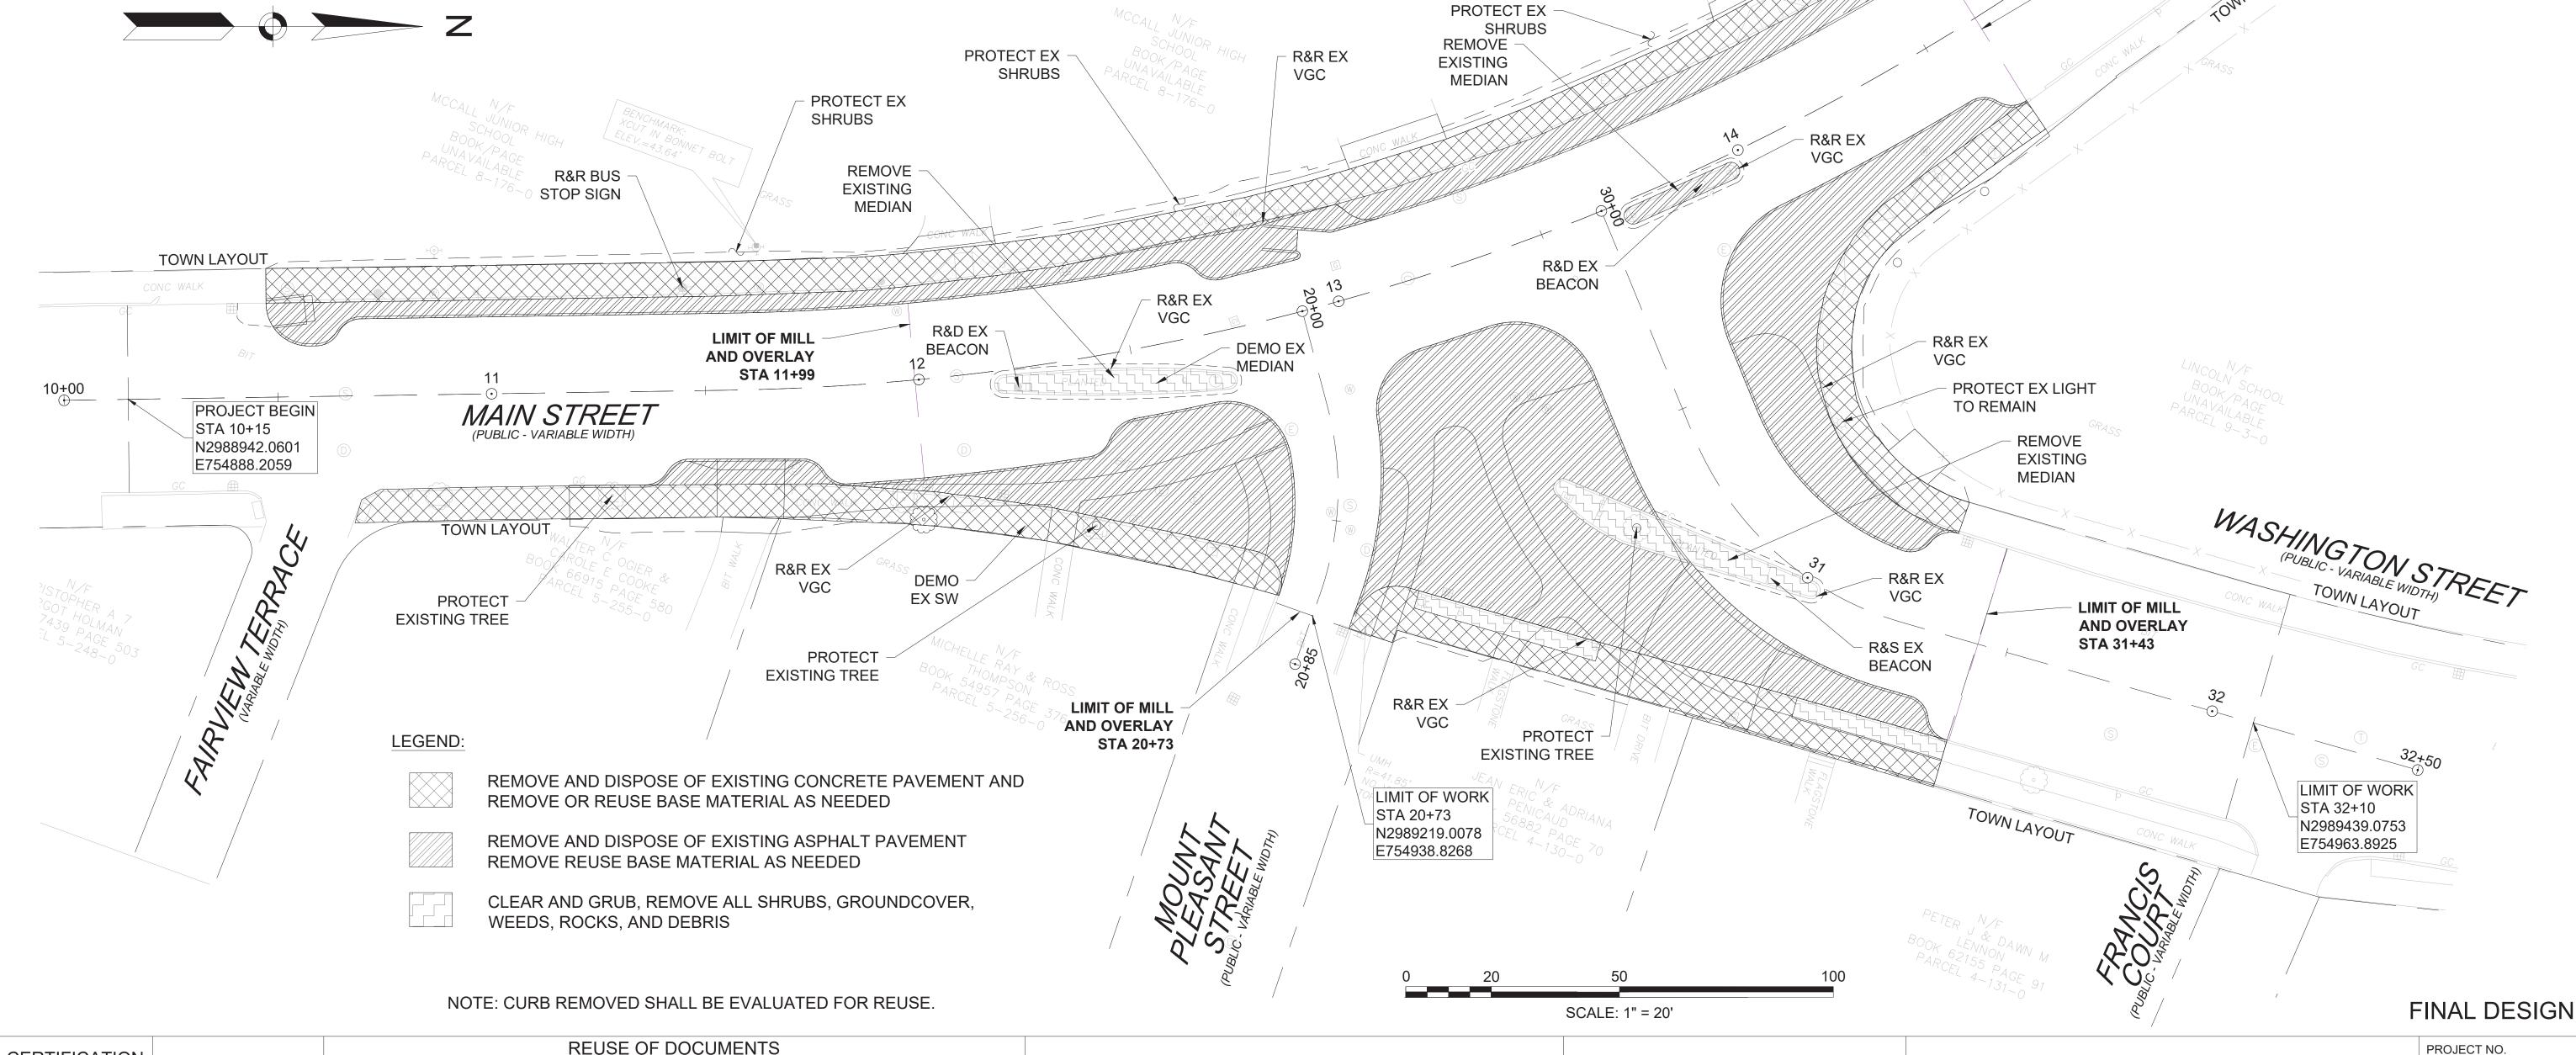
MYSTIC VALLEY PARKWAY EXISTING CONDITIONS

	60139
DATE	
	3/18/2020
DRAWING NO.	
	E.02
SHEET NO.	
	6 OF 39

DEMOLITION & SITE PREPARATION NOTES:

- 1. THE CONTRACTOR SHALL INCLUDE IN THE BID THE COST OF REMOVING ANY EXISTING SITE FEATURES AND APPURTENANCES NECESSARY TO ACCOMPLISH THE CONSTRUCTION OF THE PROPOSED SITE IMPROVEMENTS. THE CONTRACTOR SHALL ALSO INCLUDE IN THE BID THE COST NECESSARY TO RESTORE SUCH ITEMS IF THEY ARE SCHEDULED TO REMAIN AS PART OF THE FINAL SITE IMPROVEMENTS. REFER TO PLANS TO DETERMINE EXCAVATION, DEMOLITION AND TO DETERMINE THE LOCATION OF THE PROPOSED SITE IMPROVEMENTS.
- 2. THE OWNER RESERVES THE RIGHT TO REVIEW ALL MATERIALS DESIGNATED FOR REMOVAL AND TO RETAIN OWNERSHIP OF SUCH MATERIALS. IF THE OWNER RETAINS ANY MATERIAL THE CONTRACTOR SHALL MAKE ARRANGEMENTS WITH THE OWNER TO HAVE THOSE MATERIALS REMOVED OFF SITE AT NO ADDITIONAL COST.
- 3. UNLESS SPECIFICALLY NOTED TO BE SAVED / STOCKPILED OR REUSED / RELOCATED , ALL SITE FEATURES CALLED FOR REMOVAL (REM) SHALL BE REMOVED WITH THEIR FOOTINGS, ATTACHMENTS, BASE MATERIAL, ETC, TRANSPORTED FROM THE SITE TO BE DISPOSED OF IN A LAWFUL MANNER AT AN ACCEPTABLE DISPOSAL SITE AND AT NO COST TO THE OWNER.
- 4. ALL EXISTING SITE FEATURES TO REMAIN SHALL BE PROTECTED THROUGHOUT THE CONSTRUCTION PERIOD. ANY FEATURES DAMAGED DURING CONSTRUCTION OPERATIONS SHALL BE REPAIRED OR REPLACED TO THE SATISFACTION OF THE OWNER'S REPRESENTATIVE AT NO ADDITIONAL COST.
- DURING EARTHWORK OPERATIONS, CONTRACTOR SHALL TAKE CARE TO NOT DISTURB EXISTING MATERIALS TO REMAIN, OUTSIDE THE LIMITS OF EXCAVATION AND BACKFILL AND SHALL TAKE WHATEVER MEASURES NECESSARY, AT THE CONTRACTOR'S EXPENSE, TO PREVENT ANY EXCAVATED MATERIAL FROM COLLAPSING. ALL BACKFILL MATERIALS SHALL BE PLACED AND COMPACTED AS SPECIFIED TO THE SUBGRADE REQUIRED FOR THE INSTALLATION OF THE REMAINDER OF THE CONTRACT WORK.

- 6. IT SHALL BE THE CONTRACTOR'S OPTION, WITH CONCURRENCE OF THE OWNER, TO REUSE EXISTING GRAVEL IF IT MEETS THE REQUIREMENTS OF THE SPECIFICATIONS FOR GRAVEL BORROW.
- 7. ALL ITEMS CALLED FOR REMOVAL SHALL BE REMOVED TO FULL DEPTH INCLUDING ALL FOOTINGS, FOUNDATIONS, AND OTHER APPURTENANCES, EXCEPT AS SPECIFICALLY NOTED OTHERWISE.
- 8. 'CLEAR AND GRUB VEGETATION' SHALL INCLUDE REMOVAL OF GRASS, SHRUBS, AND UNDERBRUSH, REMOVAL OF ROOTS, ROUGH GRADING, INSTALLATION OF LOAM (IF APPLICABLE), FINE GRADING, SEEDING AND TURF ESTABLISHMENT BY THE CONTRACTOR.
- 9. TREES DESIGNATED FOR REMOVAL SHALL BE TAGGED BY CONTRACTOR AND APPROVED BY OWNER'S REPRESENTATIVE PRIOR TO COMMENCEMENT OF CONSTRUCTION. ALL STUMPS AND ROOTS SHALL BE REMOVED WHERE REQUIRED.
- 10. THE STORAGE OF MATERIALS AND EQUIPMENT WILL BE PERMITTED AT LOCATIONS DESIGNATED BY OWNER OR OWNER'S REPRESENTATIVE. PROTECTION OF STORED MATERIALS AND EQUIPMENT SHALL BE THE SOLE RESPONSIBILITY OF THE CONTRACTOR.
- 11. STRIP & STORE EXISTING TOPSOIL FOR LATER REUSE WHERE APPROPRIATE, AND AS NOTED ON PLAN, WITH APPROPRIATE EROSION AND SEDIMENT CONTROLS.
- 12. LOAM / TOP SOIL DESIGNATED FOR REUSE AS GENERAL FILL SHALL BE BLENDED WITH SUITABLE BORROW MATERIAL AS SPECIFIED.
- 13. THE CONTRACTOR SHALL PROTECT EXISTING TREES TO REMAIN, CONTRACTOR SHALL INSTALL TREE PROTECTION BARRIER AFTER CLEARING UNDERBRUSH AND TAKE DUE CARE TO PREVENT INJURY TO TREES DURING CLEARING OPERATIONS.



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MCCALL MIDDLE SCHOOL
TRAFFIC IMPROVEMENT PROJECT

MAIN STREET AT WASHINGTON STREET

DEMOLITION PLAN

SHEET NO.

60139

3/18/2020

D.01

7 OF 39

AND OVERLAY STA 14+63 PROJECT END

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STA 15+71

DEMOLITION & SITE PREPARATION NOTES:

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- 3. UNLESS SPECIFICALLY NOTED TO BE SAVED / STOCKPILED OR REUSED / RELOCATED, ALL SITE FEATURES CALLED FOR REMOVAL (REM) SHALL BE REMOVED WITH THEIR FOOTINGS, ATTACHMENTS, BASE MATERIAL, ETC, TRANSPORTED FROM THE SITE TO BE DISPOSED OF IN A LAWFUL MANNER AT AN ACCEPTABLE DISPOSAL SITE AND AT NO COST TO THE OWNER.
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- 5. DURING EARTHWORK OPERATIONS, CONTRACTOR SHALL TAKE CARE TO NOT DISTURB EX MATERIALS TO REMAIN, OUTSIDE THE LIMITS OF EXCAVATION AND BACKFILL AND SHALL TAKE WHATEVER MEASURES NECESSARY, AT THE CONTRACTOR'S EXPENSE, TO PREVENT ANY EXCAVATED MATERIAL FROM COLLAPSING ALL BACKFILL MATERIALS SHALL BE PLACED AND COMPACTED AS SPECIFIED TO THE SUBGRADE REQUIRED FOR THE INSTALLATION OF THE REMAINDER OF THE CONTRACT WORK.
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- 7. ALL ITEMS CALLED FOR REMOVAL SHALL BE REMOVED TO FULL DEPTH INCLUDING ALL FOOTINGS, FOUNDATIONS, AND OTHER APPURTENANCES, EXCEPT AS SPECIFICALLY NOTED OTHERWISE.
- 8. 'CLEAR AND GRUB VEGETATION' SHALL INCLUDE REMOVAL OF GRASS, SHRUBS, AND UNDERBRUSH, REMOVAL OF ROOTS, ROUGH GRADING, INSTALLATION OF LOAM (IF APPLICABLE), FINE GRADING, SEEDING AND TURF ESTABLISHMENT BY THE CONTRACTOR.
- 9. TREES DESIGNATED FOR REMOVAL SHALL BE TAGGED BY CONTRACTOR AND APPROVED BY OWNER'S REPRESENTATIVE PRIOR TO COMMENCEMENT OF CONSTRUCTION. ALL STUMPS AND ROOTS SHALL BE REMOVED WHERE REQUIRED.

APPROPRIATE EROSION AND SEDIMENT CONTROLS.

- 12. LOAM / TOP SOIL DESIGNATED FOR REUSE AS GENERAL FILL SHALL BE BLENDED WITH SUITABLE BORROW MATERIAL AS SPECIFIED.
- 13. THE CONTRACTOR SHALL PROTECT EX TREES TO REMAIN, CONTRACTOR SHALL INSTALL TREE PROTECTION BARRIER AFTER CLEARING UNDERBRUSH AND TAKE DUE CARE TO PREVENT INJURY TO TREES DURING CLEARING OPERATIONS.

LIMIT OF WORK

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- PROTECT EX

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LIMIT OF MILL

& OVERLAY

STA 20+30

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LEGEND:

REMOVE AND DISPOSE OF EX CONCRETE PAVEMENT AND REMOVE OR REUSE BASE MATERIAL AS NEEDED

REMOVE AND DISPOSE OF EX ASPHALT PAVEMENT REMOVE REUSE BASE MATERIAL AS NEEDED



- PROTECT EXPROTECT EX

LIGHT TO

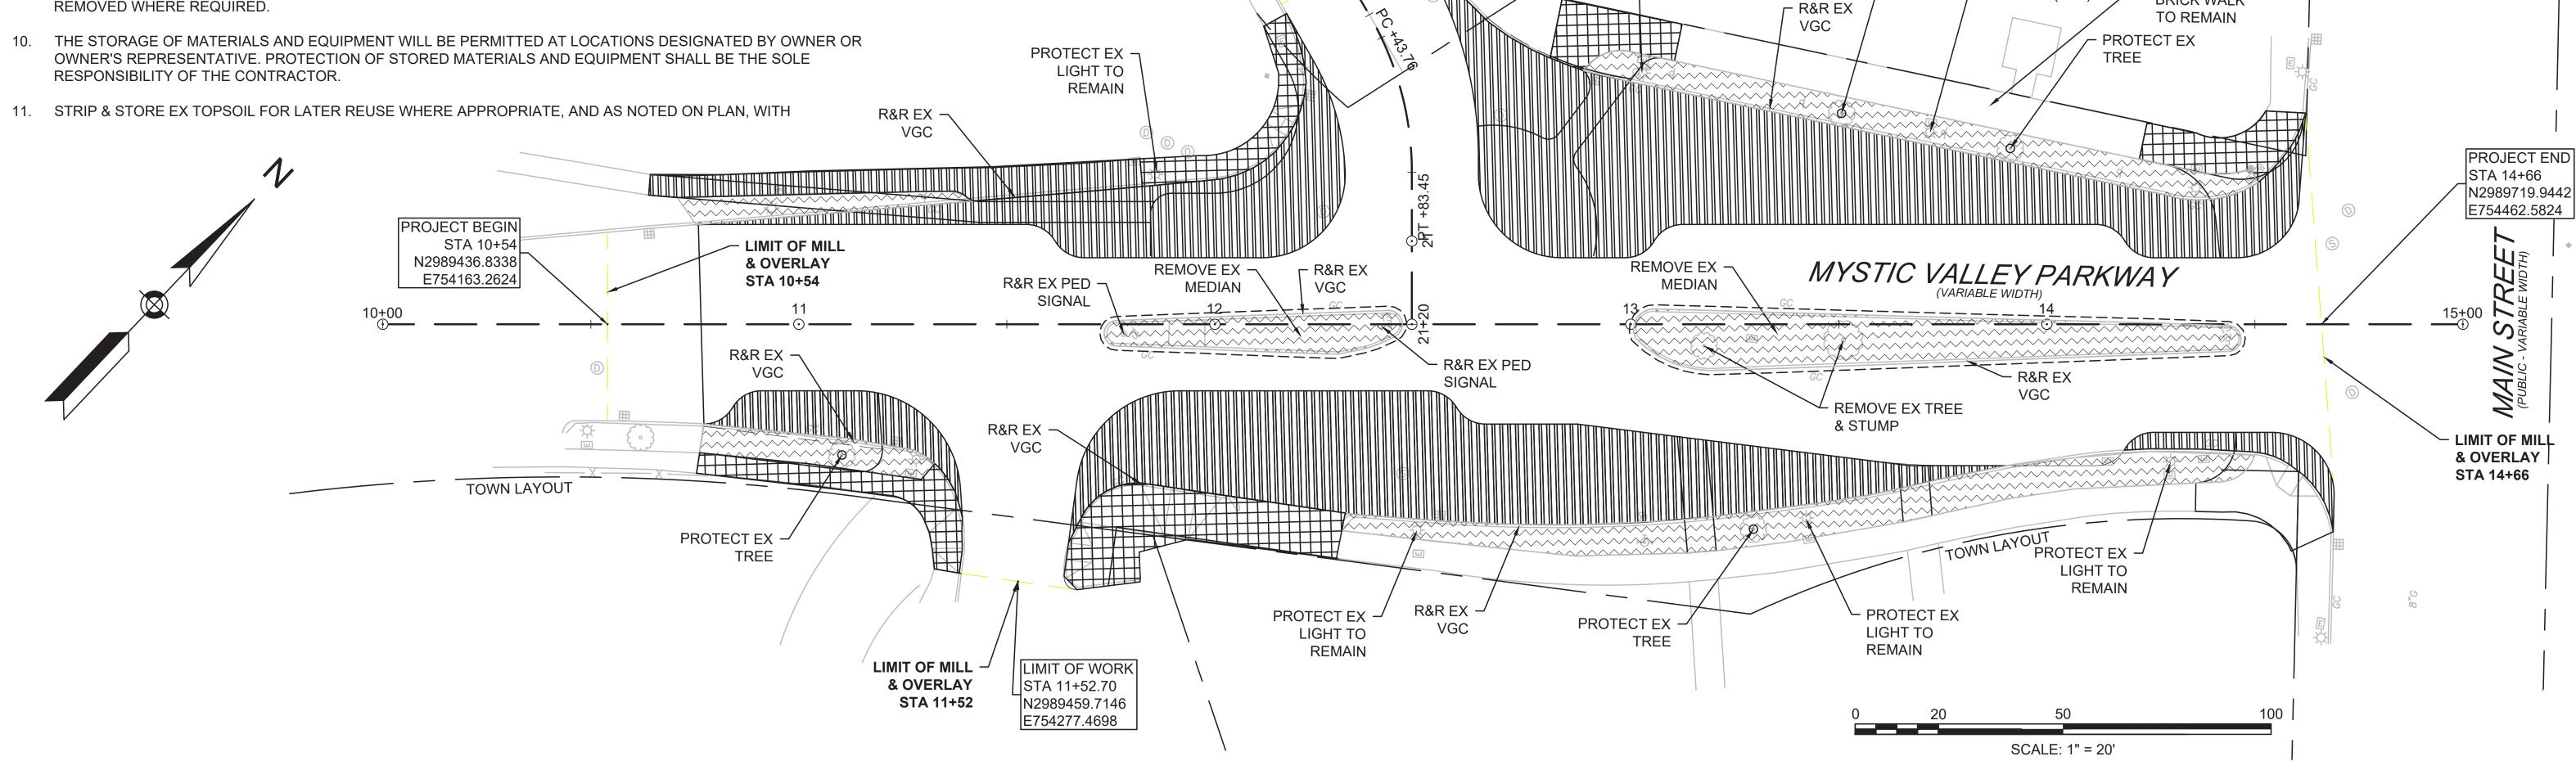
REMAIN (TYP)

CLEAR AND GRUB, REMOVE ALL SHRUBS, GROUNDCOVER, WEEDS, ROCKS, AND DEBRIS

NOTE: CURB REMOVED SHALL BE EVALUATED FOR REUSE.

- PROTECT EX

BRICK WALK



PROFESSIONAL CERTIFICATION

I HEREBY CERTIFY THAT THESE PLANS
WERE PREPARED OR APPROVED BY
ME, AND THAT I AM A DULY LICENSED
PROFESSIONAL ENGINEER UNDER THE
LAWS OF THE COMMONWEALTH OF
MASSACHUSETTS,
LICENSE NO. 49208,
EXPIRATION DATE:6/30/2020.



REUSE OF DOCUMENTS

ALL DRAWINGS ARE INSTRUMENTS OF PROFESSIONAL SERVICE FOR THIS PROJECT.

REUSE OR ALTERATION IS AT THE USER'S SOLE RISK.

DSGN CBK

DR RPI

CHK KMF

APVD ELG NO. DATE REVISION BY APVD



MCCALL MIDDLE SCHOOL
TRAFFIC IMPROVEMENT PROJECT

MYSTIC VALLEY PARKWAY DEMOLITION PLAN

DATE

3/18/2020

DRAWING NO.

D.02


SHEET NO.


8 OF 39

FINAL DESIGN

PROJECT NO.

GENERAL NOTES: UTILITY NOTE: THIS PLAN IS BASED UPON AN ON-THE-GROUND SURVEY PERFORMED BY BSC GROUP, INC. IN OCTOBER AND NOVEMBER, 2018. 1. EXISTING UTILITIES, WHERE SHOWN HEREON, ARE APPROXIMATE. THE CONTRACTOR SHALL BE RESPONSIBLE FOR PROPERLY LOCATING AND HORIZONTAL DATUM IS THE NORTH AMERICAN DATUM OF 1983 (NAD 83) AS DERIVED PROJECT END COORDINATING ANY ON-SITE ACTIVITY WITH WINCHESTER DEPARTMENT OF FROM GPS SURVEY PERFORMED BY BSC GROUP, INC. STA 15+71 PUBLIC WORKS AND THE APPROPRIATE UTILITY COMPANY AND MAINTAINING N2989458.8792 EXISTING UTILITY SYSTEM SERVICE. THE CONTRACTOR SHALL VERIFY SIZE, VERTICAL DATUM IS THE NORTH AMERICAN VERTICAL DATUM OF 1988 (NAVD 88) AS E754733.3307 LOCATION AND INVERTS OR UTILITIES AND STRUCTURES AS REQUIRED DERIVED FROM GPS SURVEY PERFORMED BY BSC GROUP, INC. PRIOR TO THE START OF CONSTRUCTION. PROPOSED PLANTING TABLE MEET EXIST ABBREVIATION | SYMBOL QTY **BOTANICAL NAME** COMMON NAME SIZE COMMENTS MAACKIA AMURENSIS AMUR MAACKIA 2"-2.5" MAIN AND OVERLAY STA 14+63 STREET CONST. B PROP VGC (TYPE VA4) PROP CEM BIKE RAMP-1 **CONC SW** MEET EXIST MEET EXIST LIMIT OF **GRADING** (TYP) **BIKE RAMP-2** PROP VGC TOWN LAYOUT RET (TYPE VA4) INFILTRATIVE PROP LP & EHH WASHINGTON LIMIT OF MILL **STREET** PROP CEM **AND OVERLAY** CONST. **CONC SW** STA 11+99 PROP LOAM & PROP CEM SEED MAIN STREE PROJECT BEGIN PROP VGC - CONC SW PROP LOAM PROP HMA STA 10+15 (TYPE VA4) & SEED PROP MOUNTABLE GRANITE CURB N2988942.0601 DWY-1 W/ 6' TRANSITION CURBS RET E754888.2059 RET VGC SEE DETAILS SHEET 32 TREE **RET FENCE** TOWN LAYOUT AND OVERLAY R&R EX **CONSTRUCTION NOTES: RET TREE &** R&R FIRE PULL BOX TREE PIT *PLACEMENT REQUIRES FOR DRAINAGE AND UTILITY PLAN SEE SHEET 27. APPROVAL FROM FIRE LIMIT OF WORK DEPARTMENT MEET STA 32+10 2. FOR WHEELCHAIR RAMP DETAILS SEE SHEET 34. EXIST N2989439.0753 CIT CB TO **EXIST** E754963.8925 FOR CONSTRUCTION DETAILS SEE SHEETS 30-33. LIMIT OF MILL **AND OVERLAY** FOR PROPOSED PAVEMENT MARKINGS AND SIGNAGE SEE SHEET 20. STA 20+73 DEM EX THE TERM "MEET EX" MEANS TO MEET BOTH THE EXISTING ALIGNMENT AND ELEVATION. MOUNT **PLEASANT** LIMIT OF WORK AN UNOBSTRUCTED PATH OF TRAVEL WITH A MINIMUM WIDTH OF 3'-3" SHALL BE MAINTAINED PAST ALL TOWN LAYOUT STREET STA 20+73 OBSTRUCTIONS (UTILITY POLES, SIGNS, MAILBOXES, ALONG DRIVEWAY OPENINGS, ETC.) CONST. B N2989219.0078 PROP CEM E754938.8268 CONC SW PROPOSED GRANITE TRANSITION CURBING SHALL BE USED AT ALL WHEELCHAIR RAMP LOCATIONS AND TO MEET EXISTING PAVEMENT WHEN REQUIRED. WHERE AN EXISTING UTILITY IS FOUND TO CONFLICT WITH THE PROPOSED WORK, THE LOCATION, ELEVATION AND SIZE OF THE UTILITY SHALL BE ACCURATELY DETERMINED WITHOUT DELAY BY THE CONTRACTOR, AND THE INFORMATION FURNISHED TO THE ENGINEER FOR RESOLUTION OF THE CONFLICT. LEGEND: ALL PRIVATELY OWNED UTILITY STRUCTURES (GAS GATES, ELECTRIC/TELEPHONE MANHOLES, ETC.) SHALL BE CEMENT CONCRETE SIDEWALK/WHEELCHAIR RAMP/DRIVEWAY ADJUSTED TO FINISHED GRADE BY THE PRIVATE UTILITY COMPANY, UNLESS DIRECTED OTHERWISE. THE LOAM & SEED CONTRACTOR SHALL COORDINATE WITH PRIVATE UTILITY COMPANIES FOR THE ALTERATION AND ADJUSTMENT, AS NECESSARY. HOT MIX ASPHALT SIDEWALK/DRIVEWAY 10. AREAS OUTSIDE THE LIMITS OF PROPOSED WORK DISTURBED BY THE CONTRACTOR'S OPERATIONS SHALL BE RESTORED BY THE CONTRACTOR TO THEIR ORIGINAL CONDITION AT THE CONTRACTORS EXPENSE FINAL DESIGN SCALE: 1" = 20' 11. STONE BOUNDS ARE TO BE PROTECTED AND/OR RESET BY A REGISTERED LAND SURVEYOR. REUSE OF DOCUMENTS PROJECT NO. PROFESSIONAL CERTIFICATION ALL DRAWINGS ARE INSTRUMENTS OF PROFESSIONAL SERVICE FOR THIS PROJECT. 60139 REUSE OR ALTERATION IS AT THE USER'S SOLE RISK. MCCALL MIDDLE SCHOOL I HEREBY CERTIFY THAT THESE PLANS DATE WERE PREPARED OR APPROVED BY TRAFFIC IMPROVEMENT PROJECT 3/18/2020 CBK ME, AND THAT I AM A DULY LICENSED MAIN STREET AT WASHINGTON STREET DRAWING NO. PROFESSIONAL ENGINEER UNDER THE RPI DESIGN www.tooledesign.com LAWS OF THE COMMONWEALTH OF C.01 CONSTRUCTION PLAN MASSACHUSETTS, **KMF** SHEET NO. LICENSE NO. 49208, ELG NO. DATE EXPIRATION DATE:6/30/2020 REVISION BY APVD 9 OF 39

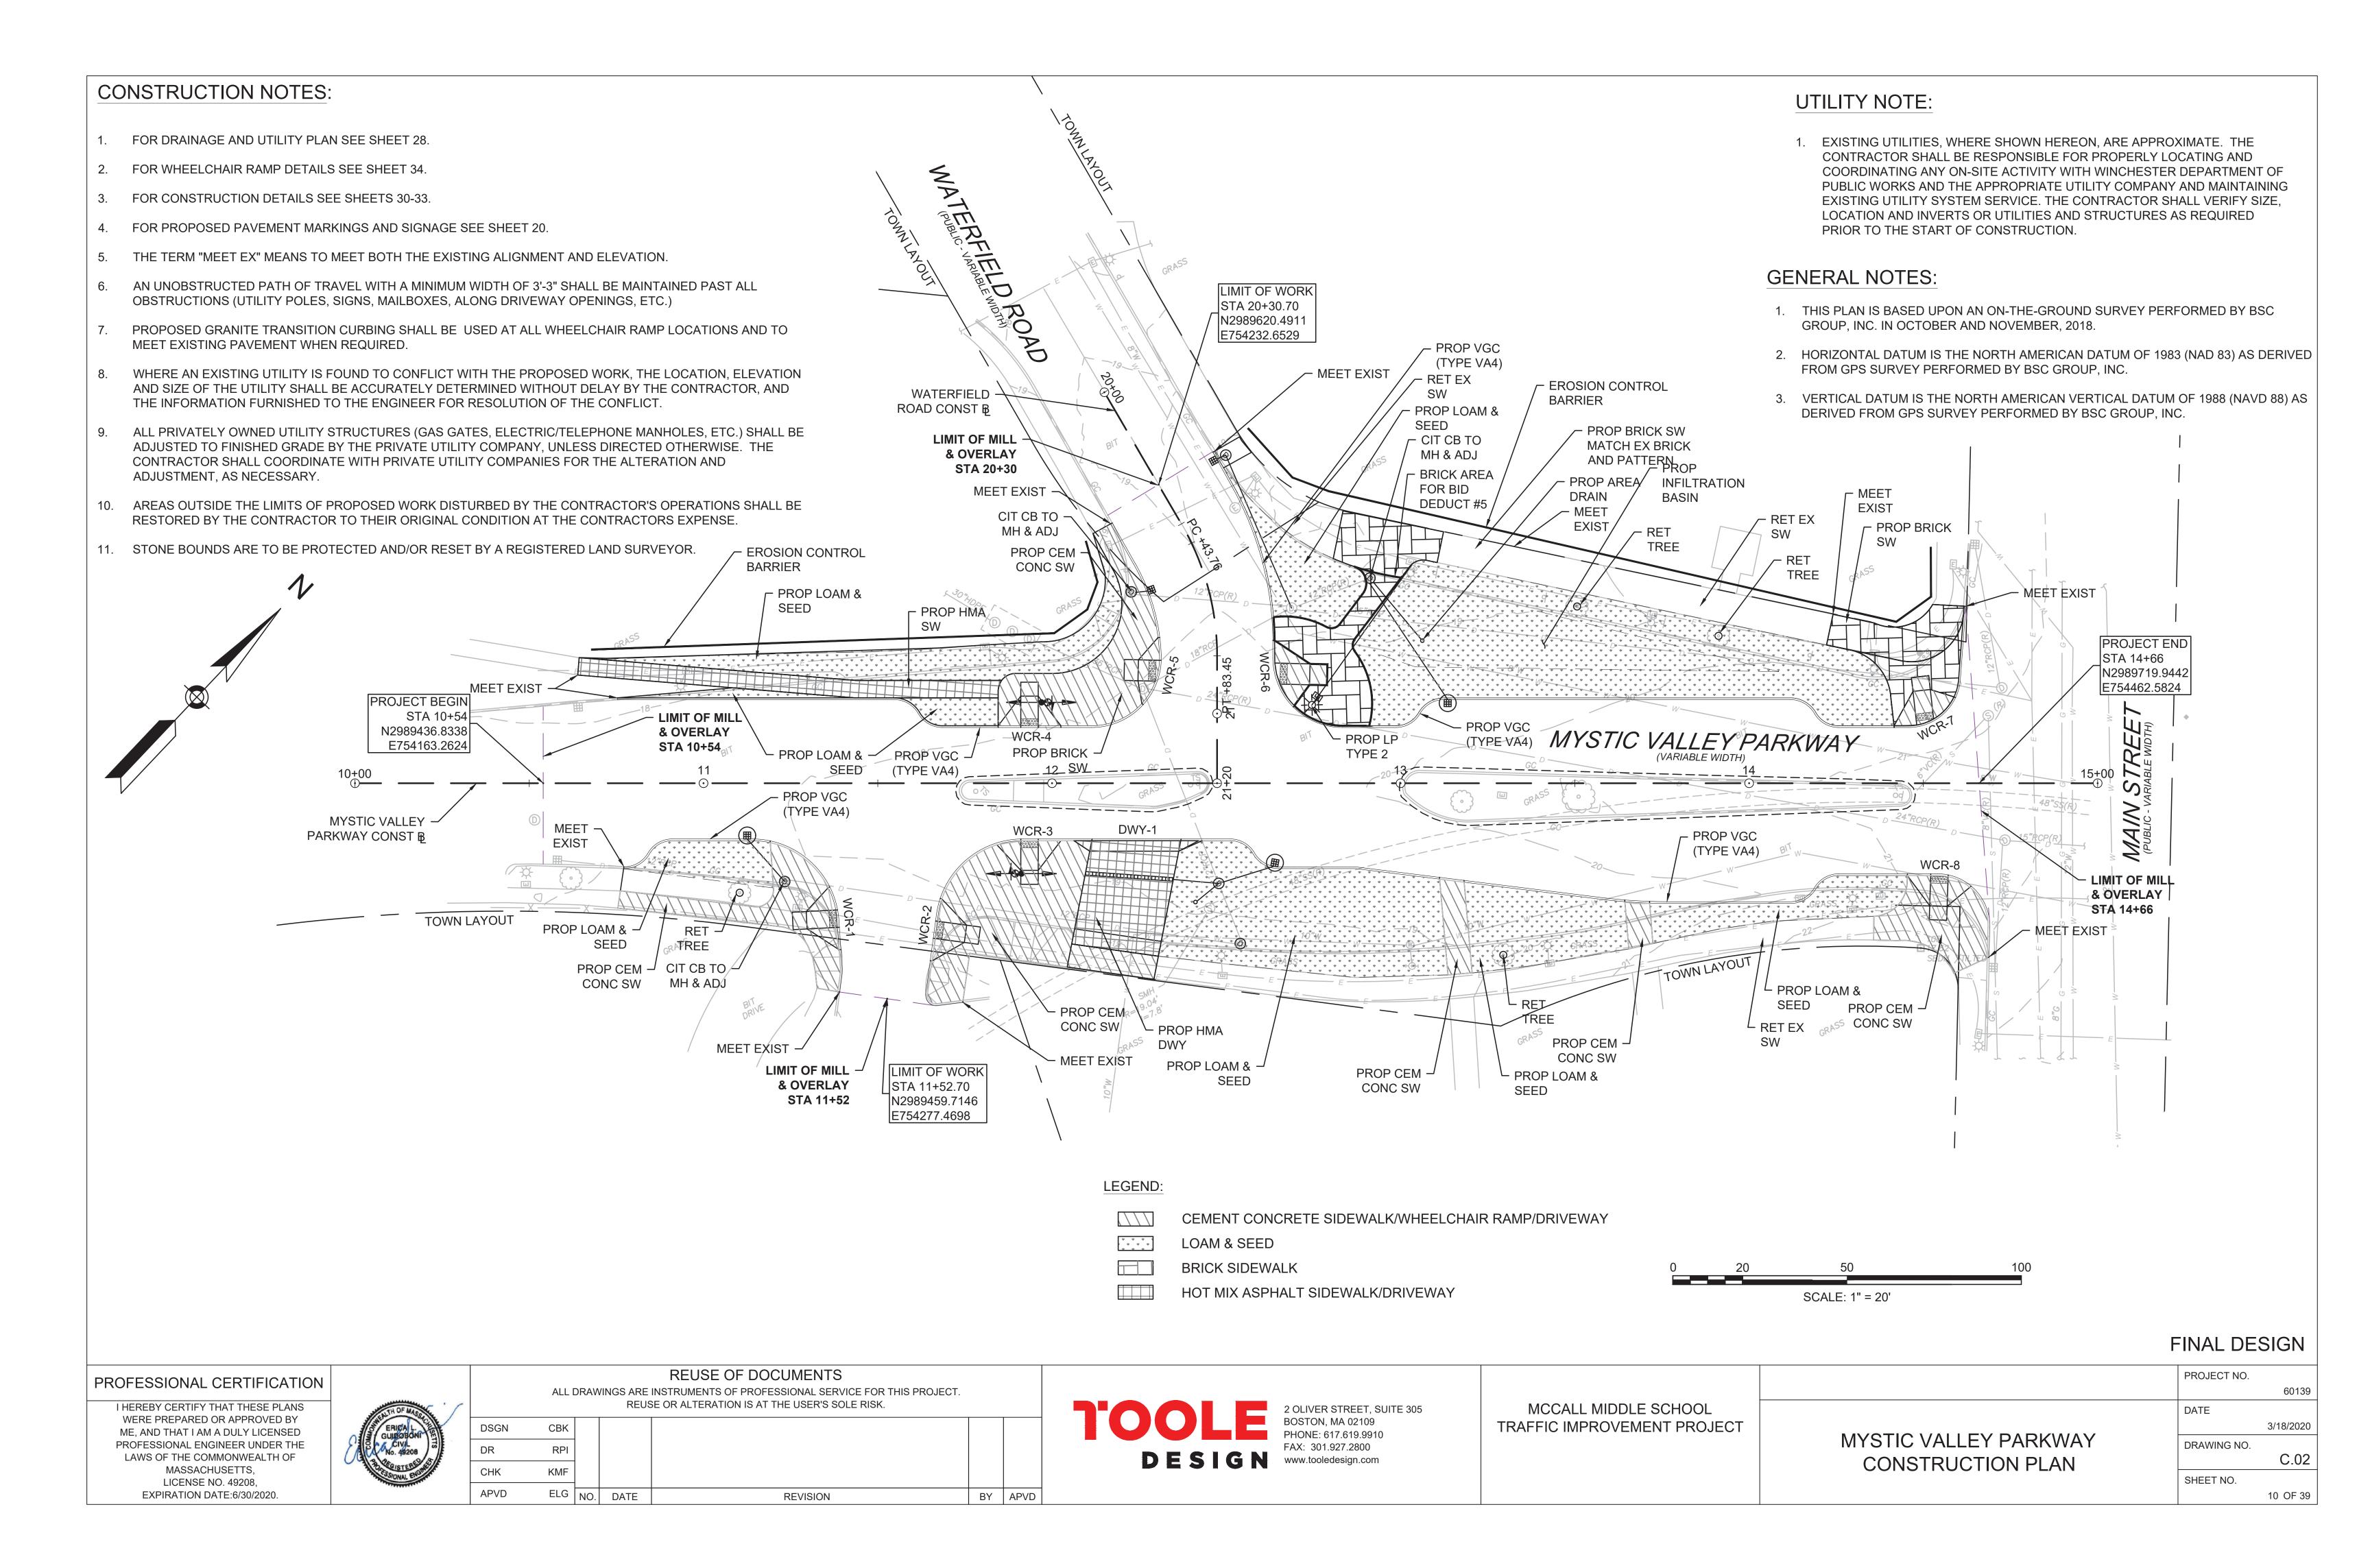

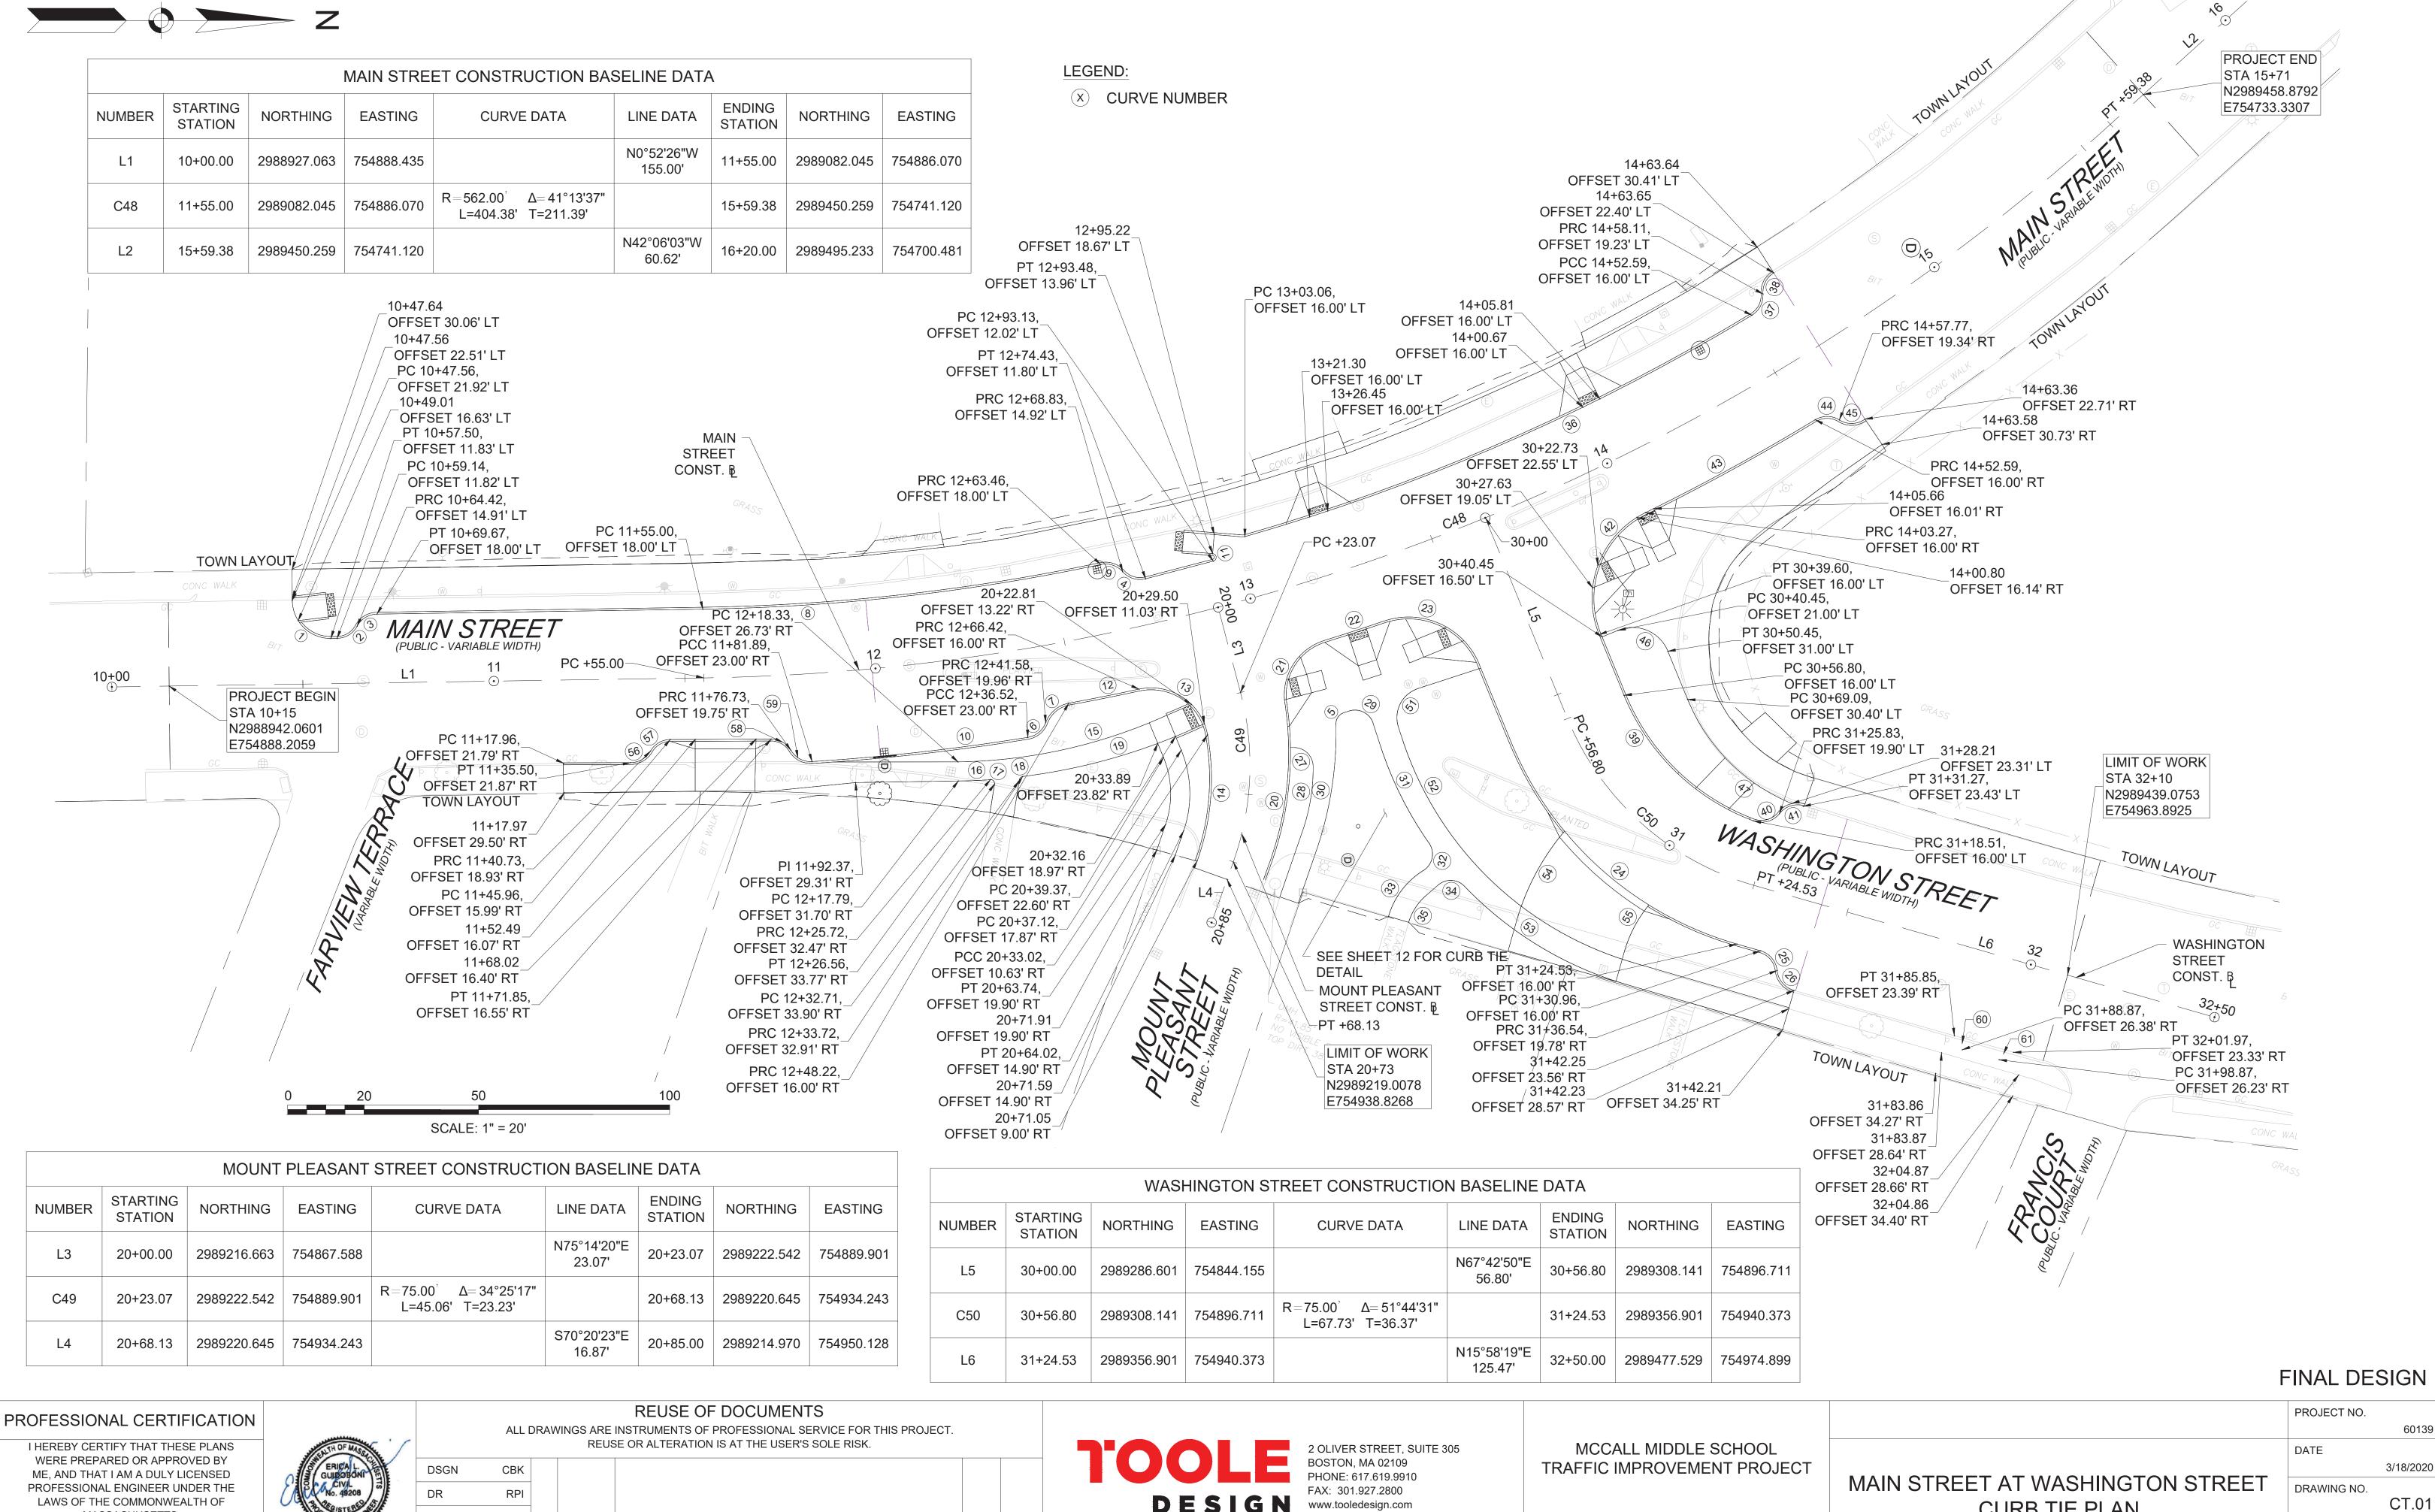

LAWS OF THE COMMONWEALTH OF MASSACHUSETTS, LICENSE NO. 49208, EXPIRATION DATE:6/30/2020.




					NEODE OF DOCOMENTO				
1	ALL DRAWINGS ARE INSTRUMENTS OF PROFESSIONAL SERVICE FOR THIS PROJECT. REUSE OR ALTERATION IS AT THE USER'S SOLE RISK.								
	DSGN	CBK							
	DR	RPI							
	CHK	KMF							
	APVD	ELG	NO.	DATE	REVISION	BY	APVD		

DESIGN HAX: 301.927.2800 www.tooledesign.com

CURB TIE PLAN SHEET NO.

CURVE# LENGTH DIRECTION/DELTA RADIUS TANGENT 1 15.75 90"13'41" 10.00 10.04 2 6.42 61"20'15" 6.00 3.56 3 6.39 61"00'41" 6.00 3.54 4 6.63 63"19'56" 6.00 3.70 5 3.84 73"2'142" 3.00 2.23 6 6.36 60"44'18" 6.00 3.51 7 8.28 59"19'13" 8.00 4.56 8 104.99 11"03'26" 544.00 52.66 9 6.34 60"34'03" 6.00 3.50 10 56.86 5"34'10" 585.00 28.45 11 2.80 160"37'42" 1.00 5.86 12 18.72 1"51'21" 578.00 9.36 13 24.07 91"55'58" 15.00 15.51 14 33.47 29"57'41" 64.00 17.13 15			CURVE TABLE		
2 6.42 61°20′15° 6.00 3.56 3 6.39 61°00′41° 6.00 3.54 4 6.63 63°19′56° 6.00 3.70 5 3.84 73°21′42° 3.00 2.23 6 6.36 60°44′18° 6.00 3.51 7 8.28 59°19′13° 8.00 4.56 8 104.99 11°03′26° 544.00 52.66 9 6.34 60°34′03° 6.00 3.50 10 56.86 5°34′10° 585.00 28.45 11 2.80 160°37′42° 1.00 5.86 12 18.72 1°51′21° 578.00 9.36 13 24.07 91°55′56° 1.00 17.13 15 63.45 25°34′32° 142.15 32.26 16 8.42 3°05′32° 156.00 4.21 17 1.80 102°57′26° 1.00 0.75 18 1.29 73°55′48° 1.00 0.75 19 49.71 18°15′30° 156.00 25.07 20 42.35 28°12′54° 86.00 21.61 21 21.29 81°20′17° 15.00 12.89 22 16.32 1°37′05° 578.00 8.16 23 30.21 86°32′55° 20.00 18.83 24 82.18 51°44′31° 91.00 44.13 25 7.15 68°17′57° 6.00 4.07 26 7.29 69°34′31° 6.00 4.77 27 8.14 93°16′33° 5.00 5.29 28 16.81 19°20′39° 49.79 8.49 29 7.85 90°00′00° 5.00 5.00 30 30.03 18°0′57° 95.51 15.14 31 28.55 17°02′21° 96.00 14.38 32 8.15 93°22′29° 5.00 5.30 33 15.45 42°09′46° 21.00 4.34 36 145.27 15°14′38° 540.00 4.34 36 145.27 15°14′38° 540.00 4.34 36 145.27 15°14′38° 540.00 4.39 41 7.24 69°07′04° 6.00 4.39 41 7.24 69°07′04° 6.00 4.39 44 6.64 63°23′48° 6.00 3.71	CURVE#	LENGTH	DIRECTION/DELTA	RADIUS	TANGENT
3 6.39 61°00′41" 6.00 3.54 4 6.63 63°19′56" 6.00 3.70 5 3.84 73°21′42" 3.00 2.23 6 6.36 60°44′18" 6.00 3.51 7 8.28 59°19′13" 8.00 4.56 8 104.99 11°03′26" 544.00 52.66 9 6.34 60°34′03" 6.00 3.50 10 56.86 5°34′10" 585.00 28.45 11 2.80 160°37′42" 1.00 5.86 12 18.72 1°51′21" 578.00 9.36 13 24.07 91°5558" 15.00 15.51 14 33.47 29°57′41" 64.00 17.13 15 63.45 25°34′32" 142.15 32.26 16 8.42 3°05′32" 156.00 4.21 17 1.80 102°57′26" 1.00 1.26 18 1.29 <td>1</td> <td>15.75</td> <td>90°13'41"</td> <td>10.00</td> <td>10.04</td>	1	15.75	90°13'41"	10.00	10.04
4 6.63 63°19′56° 6.00 3.70 5 3.84 73°21′42° 3.00 2.23 6 6.36 60°44′18° 6.00 3.51 7 8.28 59°19′13° 8.00 4.56 8 104.99 11°03′26° 544.00 52.66 9 6.34 60°34′03° 6.00 3.50 10 56.86 5°34′10° 585.00 28.45 11 2.80 160°37′42° 1.00 5.86 12 18.72 1°51′21° 578.00 9.36 13 24.07 91°55′58° 15.00 15.51 14 33.47 29°57′41° 64.00 17.13 15 63.45 25°34′32° 142.15 32.26 16 8.42 3°05′32° 156.00 4.21 17 1.80 102°57′26° 1.00 1.26 18 1.29 73°55′48° 1.00 0.75 19 49.71<	2	6.42	61°20'15"	6.00	3.56
5 3.84 73°21'42" 3.00 2.23 6 6.36 60°44'18" 6.00 3.51 7 8.28 59°19'13" 8.00 4.56 8 104.99 11°03'26" 544.00 52.66 9 6.34 60°34'03" 6.00 3.50 10 56.86 5°34'10" 585.00 28.45 11 2.80 160°37'42" 1.00 5.86 12 18.72 1°51'21" 578.00 9.36 13 24.07 91°55'58" 15.00 15.51 14 33.47 29°57'41" 64.00 17.13 15 63.45 25°34'32" 142.15 32.26 16 8.42 3°05'32" 156.00 4.21 17 1.80 102°57'26" 1.00 1.26 18 1.29 73°55'48" 1.00 0.75 19 49.71 18°15'30" 156.00 25.07 20 4	3	6.39	61°00'41"	6.00	3.54
6 6.36 60°44'18" 6.00 3.51 7 8.28 59°19'13" 8.00 4.56 8 104.99 11"03'26" 544.00 52.66 9 6.34 60°34'03" 6.00 3.50 10 56.86 5°34'10" 585.00 28.45 11 2.80 160°37'42" 1.00 5.86 12 18.72 1°51'21" 578.00 9.36 13 24.07 91°55'58" 15.00 15.51 14 33.47 29°57'41" 64.00 17.13 15 63.45 25°34'32" 142.15 32.26 16 8.42 3°05'32" 156.00 4.21 17 1.80 102°57'26" 1.00 1.26 18 1.29 73°55'48" 1.00 0.75 19 49.71 18°15'30" 156.00 25.07 20 42,35 28°12'54" 86.00 21.61 21 <	4	6.63	63°19'56"	6.00	3.70
7 8.28 59"19'13" 8.00 4.56 8 104.99 11"03'26" 544.00 52.66 9 6.34 60"34'03" 6.00 3.50 10 56.86 5"34'10" 585.00 28.45 11 2.80 160"37'42" 1.00 5.86 12 18.72 1"51'21" 578.00 9.36 13 24.07 91"55'58" 15.00 15.51 14 33.47 29"57'41" 64.00 17.13 15 63.45 25"34'32" 142.15 32.26 16 8.42 3"05'32" 156.00 4.21 17 1.80 102"57'26" 1.00 1.26 18 1.29 73"55'48" 1.00 0.75 19 49.71 18"15'30" 156.00 25.07 20 42.35 28"12'54" 86.00 21.61 21 21.29 81"20'17" 15.00 12.89 22	5	3.84	73°21'42"	3.00	2.23
8	6	6.36	60°44'18"	6.00	3.51
9 6.34 60°34′03" 6.00 3.50 10 56.86 5°34′10" 585.00 28.45 11 2.80 160°37′42" 1.00 5.86 12 18.72 1°51′21" 578.00 9.36 13 24.07 91°55′58" 15.00 15.51 14 33.47 29°57′41" 64.00 17.13 15 63.45 25°34′32" 142.15 32.26 16 8.42 3°05′32" 156.00 4.21 17 1.80 102°57′26" 1.00 1.26 18 1.29 73°55′48" 1.00 0.75 19 49.71 18°15′30" 156.00 25.07 20 42.35 28°12′54" 86.00 21.61 21 21.29 81°20′17" 15.00 12.89 22 16.32 1°37′05" 578.00 8.16 23 30.21 86°32′55" 20.00 18.83 24 82.18 51°44′31" 91.00 44.13 25 7.15 68°17′57" 6.00 4.07 26 7.29 69°34′31" 6.00 4.17 27 8.14 93°16′33" 5.00 5.29 28 16.81 19°20′39" 49.79 8.49 29 7.85 90°00′00" 5.00 5.00 30 30.03 18°00′57" 95.51 15.14 31 28.55 17°02′21" 96.00 14.38 32 8.15 93°22′29" 5.00 5.30 33 15.45 42°09′46" 21.00 8.10 34 7.61 87°09′45" 5.00 4.76 35 8.45 32°16′20" 15.00 4.34 36 145.27 15°14′38" 546.00 73.06 37 6.57 62°45′40" 6.00 4.39 41 7.24 69°07′04" 6.00 4.39 44 6.64 63°23′48" 6.00 3.71	7	8.28	59°19'13"	8.00	4.56
10 56.86 5°34′10" 585.00 28.45 11 2.80 160°37′42" 1.00 5.86 12 18.72 1°51′21" 578.00 9.36 13 24.07 91°55′58" 15.00 15.51 14 33.47 29°57′41" 64.00 17.13 15 63.45 25°34′32" 142.15 32.26 16 8.42 3°05′32" 156.00 4.21 17 1.80 102″57′26" 1.00 1.26 18 1.29 73°55′48" 1.00 0.75 19 49.71 18°15′30" 156.00 25.07 20 42.35 28°12′54" 86.00 21.61 21 21.29 81°20′17" 1500 12.89 22 16.32 1°37′05" 578.00 8.16 23 30.21 86°32′55" 20.00 18.83 24 82.18 51°44′31" 91.00 4.13 25	8	104.99	11°03'26"	544.00	52.66
11 2.80 160"37'42" 1.00 5.86 12 18.72 1"51'21" 578.00 9.36 13 24.07 91"55'58" 15.00 15.51 14 33.47 29"57'41" 64.00 17.13 15 63.45 25"34'32" 142.15 32.26 16 8.42 3"05'32" 156.00 4.21 17 1.80 102"57'26" 1.00 1.26 18 1.29 73"55'48" 1.00 0.75 19 49.71 18"15'30" 156.00 25.07 20 42.35 28"12'54" 86.00 21.61 21 21.29 81"20'17" 15.00 12.89 22 16.32 1"37'05" 578.00 8.16 23 30.21 86"32'55" 20.00 18.83 24 82.18 51"44'31" 91.00 44.13 25 7.15 68"17'57" 6.00 4.07 26	9	6.34	60°34'03"	6.00	3.50
12 18.72 1°51'21" 578.00 9.36 13 24.07 91°55'58" 15.00 15.51 14 33.47 29°57'41" 64.00 17.13 15 63.45 25°34'32" 142.15 32.26 16 8.42 3°05'32" 156.00 4.21 17 1.80 102°57'26" 1.00 1.26 18 1.29 73°55'48" 1.00 0.75 19 49.71 18°15'30" 156.00 25.07 20 42.35 28°12'54" 86.00 21.61 21 21.29 81°20'17" 15.00 12.89 22 16.32 1°37'05" 578.00 8.16 23 30.21 86°32'55" 20.00 18.83 24 82.18 51°44'31" 91.00 44.13 25 7.15 68°17'57" 6.00 4.07 26 7.29 69°34'31" 6.00 4.76 27	10	56.86	5°34'10"	585.00	28.45
13 24.07 91°55′58″ 15.00 15.51 14 33.47 29°57′41″ 64.00 17.13 15 63.45 25°34′32″ 142.15 32.26 16 8.42 3°05′32″ 156.00 4.21 17 1.80 102°57′26″ 1.00 1.26 18 1.29 73°55′48″ 1.00 0.75 19 49.71 18°15′30″ 156.00 25.07 20 42.35 28°12′54″ 86.00 21.61 21 21.29 81°20′17″ 15.00 12.89 22 16.32 1°37′05″ 578.00 8.16 23 30.21 86°32′55″ 20.00 18.83 24 82.18 51°44′31″ 91.00 44.13 25 7.15 68°17′57″ 6.00 4.07 26 7.29 69°34′31″ 6.00 4.17 27 8.14 93°16′33″ 5.00 5.29 28	11	2.80	160°37'42"	1.00	5.86
14 33.47 29°57'41" 64.00 17.13 15 63.45 25°34'32" 142.15 32.26 16 8.42 3°05'32" 156.00 4.21 17 1.80 102°57'26" 1.00 1.26 18 1.29 73°55'48" 1.00 0.75 19 49.71 18°15'30" 156.00 25.07 20 42.35 28°12'54" 86.00 21.61 21 21.29 81°20'17" 15.00 12.89 22 16.32 1°37'05" 578.00 8.16 23 30.21 86°32'55" 20.00 18.83 24 82.18 51°44'31" 91.00 44.13 25 7.15 68°17'57" 6.00 4.07 26 7.29 69°34'31" 6.00 4.17 27 8.14 93°16'33" 5.00 5.29 28 16.81 19°20'39" 49.79 8.49 29	12	18.72	1°51'21"	578.00	9.36
15 63.45 25"34'32" 142.15 32.26 16 8.42 3"05"32" 156.00 4.21 17 1.80 102"57"26" 1.00 1.26 18 1.29 73"55'48" 1.00 0.75 19 49.71 18"15'30" 156.00 25.07 20 42.35 28"12'54" 86.00 21.61 21 21.29 81"20'17" 15.00 12.89 22 16.32 1"37'05" 578.00 8.16 23 30.21 86"32'55" 20.00 18.83 24 82.18 51"44'31" 91.00 44.13 25 7.15 68"17'57" 6.00 4.07 26 7.29 69"34'31" 6.00 4.17 27 8.14 93"16'33" 5.00 5.29 28 16.81 19"20'39" 49.79 8.49 29 7.85 90"00'00" 5.00 5.00 30 <	13	24.07	91°55'58"	15.00	15.51
16 8.42 3°05'32" 156.00 4.21 17 1.80 102°57'26" 1.00 1.26 18 1.29 73°55'48" 1.00 0.75 19 49.71 18°15'30" 156.00 25.07 20 42.35 28°12'54" 86.00 21.61 21 21.29 81°20'17" 15.00 12.89 22 16.32 1°37'05" 578.00 8.16 23 30.21 86°32'55" 20.00 18.83 24 82.18 51°44'31" 91.00 44.13 25 7.15 68°17'57" 6.00 4.07 26 7.29 69°34'31" 6.00 4.17 27 8.14 93°16'33" 5.00 5.29 28 16.81 19°20'39" 49.79 8.49 29 7.85 90°00'00" 5.00 5.00 30 30.03 18°0'57" 95.51 15.14 31 <td< td=""><td>14</td><td>33.47</td><td>29°57'41"</td><td>64.00</td><td>17.13</td></td<>	14	33.47	29°57'41"	64.00	17.13
17 1.80 102°57'26" 1.00 1.26 18 1.29 73°55'48" 1.00 0.75 19 49.71 18°15'30" 156.00 25.07 20 42.35 28°12'54" 86.00 21.61 21 21.29 81°20'17" 15.00 12.89 22 16.32 1°37'05" 578.00 8.16 23 30.21 86°32'55" 20.00 18.83 24 82.18 51°44'31" 91.00 44.13 25 7.15 68°17'57" 6.00 4.07 26 7.29 69°34'31" 6.00 4.17 27 8.14 93°16'33" 5.00 5.29 28 16.81 19°20'39" 49.79 8.49 29 7.85 90°00'00" 5.00 5.00 30 30.03 18°00'57" 95.51 15.14 31 28.55 17°02'21" 96.00 14.38 32	15	63.45	25°34'32"	142.15	32.26
18 1.29 73°55′48" 1.00 0.75 19 49.71 18°15′30" 156.00 25.07 20 42.35 28°12′54" 86.00 21.61 21 21.29 81°20′17" 15.00 12.89 22 16.32 1°37′05" 578.00 8.16 23 30.21 86°32′55" 20.00 18.83 24 82.18 51°44′31" 91.00 44.13 25 7.15 68°17′57" 6.00 4.07 26 7.29 69°34′31" 6.00 4.17 27 8.14 93°16′33" 5.00 5.29 28 16.81 19°20′39" 49.79 8.49 29 7.85 90°00′00" 5.00 5.00 30 30.03 18°00′57" 95.51 15.14 31 28.55 17°02′21" 96.00 14.38 32 8.15 93°22′29" 5.00 5.30 33 <	16	8.42	3°05'32"	156.00	4.21
19 49.71 18°15'30" 156.00 25.07 20 42.35 28°12'54" 86.00 21.61 21 21.29 81°20'17" 15.00 12.89 22 16.32 1°37'05" 578.00 8.16 23 30.21 86°32'55" 20.00 18.83 24 82.18 51°44'31" 91.00 44.13 25 7.15 68°17'57" 6.00 4.07 26 7.29 69°34'31" 6.00 4.17 27 8.14 93°16'33" 5.00 5.29 28 16.81 19°20'39" 49.79 8.49 29 7.85 90°00'00" 5.00 5.00 30 30.03 18°00'57" 95.51 15.14 31 28.55 17°02'21" 96.00 14.38 32 8.15 93°22'29" 5.00 5.30 33 15.45 42°09'46" 21.00 8.10 34 7.61 87°09'45" 5.00 4.76 35 8.45 <	17	1.80	102°57'26"	1.00	1.26
20 42.35 28°12'54" 86.00 21.61 21 21.29 81°20'17" 15.00 12.89 22 16.32 1°37'05" 578.00 8.16 23 30.21 86°32'55" 20.00 18.83 24 82.18 51°44'31" 91.00 44.13 25 7.15 68°17'57" 6.00 4.07 26 7.29 69°34'31" 6.00 4.17 27 8.14 93°16'33" 5.00 5.29 28 16.81 19°20'39" 49.79 8.49 29 7.85 90°00'00" 5.00 5.00 30 30.03 18°00'57" 95.51 15.14 31 28.55 17°02'21" 96.00 14.38 32 8.15 93°22'29" 5.00 5.30 33 15.45 42°09'46" 21.00 8.10 34 7.61 87°09'45" 5.00 4.76 35 <td< td=""><td>18</td><td>1.29</td><td>73°55'48"</td><td>1.00</td><td>0.75</td></td<>	18	1.29	73°55'48"	1.00	0.75
21 21.29 81°20'17" 15.00 12.89 22 16.32 1°37'05" 578.00 8.16 23 30.21 86°32'55" 20.00 18.83 24 82.18 51°44'31" 91.00 44.13 25 7.15 68°17'57" 6.00 4.07 26 7.29 69°34'31" 6.00 4.17 27 8.14 93°16'33" 5.00 5.29 28 16.81 19°20'39" 49.79 8.49 29 7.85 90°00'00" 5.00 5.00 30 30.03 18°00'57" 95.51 15.14 31 28.55 17°02'21" 96.00 14.38 32 8.15 93°22'29" 5.00 5.30 33 15.45 42°09'46" 21.00 8.10 34 7.61 87°09'45" 5.00 4.76 35 8.45 32°16'20" 15.00 4.34 36 1	19	49.71	18°15'30"	156.00	25.07
22 16.32 1°37'05" 578.00 8.16 23 30.21 86°32'55" 20.00 18.83 24 82.18 51°44'31" 91.00 44.13 25 7.15 68°17'57" 6.00 4.07 26 7.29 69°34'31" 6.00 4.17 27 8.14 93°16'33" 5.00 5.29 28 16.81 19°20'39" 49.79 8.49 29 7.85 90°00'00" 5.00 5.00 30 30.03 18°00'57" 95.51 15.14 31 28.55 17°02'21" 96.00 14.38 32 8.15 93°22'29" 5.00 5.30 33 15.45 42°09'46" 21.00 8.10 34 7.61 87°09'45" 5.00 4.76 35 8.45 32°16'20" 15.00 4.34 36 145.27 15°14'38" 546.00 73.06 37 <td< td=""><td>20</td><td>42.35</td><td>28°12'54"</td><td>86.00</td><td>21.61</td></td<>	20	42.35	28°12'54"	86.00	21.61
23 30.21 86°32'55" 20.00 18.83 24 82.18 51°44'31" 91.00 44.13 25 7.15 68°17'57" 6.00 4.07 26 7.29 69°34'31" 6.00 4.17 27 8.14 93°16'33" 5.00 5.29 28 16.81 19°20'39" 49.79 8.49 29 7.85 90°00'00" 5.00 5.00 30 30.03 18°00'57" 95.51 15.14 31 28.55 17°02'21" 96.00 14.38 32 8.15 93°22'29" 5.00 5.30 33 15.45 42°09'46" 21.00 8.10 34 7.61 87°09'45" 5.00 4.76 35 8.45 32°16'20" 15.00 4.34 36 145.27 15°14'38" 546.00 73.06 37 6.57 62°45'40" 6.00 3.63 39 48.54 47°08'30" 59.00 25.74 40 7.58	21	21.29	81°20'17"	15.00	12.89
24 82.18 51°44'31" 91.00 44.13 25 7.15 68°17'57" 6.00 4.07 26 7.29 69°34'31" 6.00 4.17 27 8.14 93°16'33" 5.00 5.29 28 16.81 19°20'39" 49.79 8.49 29 7.85 90°00'00" 5.00 5.00 30 30.03 18°00'57" 95.51 15.14 31 28.55 17°02'21" 96.00 14.38 32 8.15 93°22'29" 5.00 5.30 33 15.45 42°09'46" 21.00 8.10 34 7.61 87°09'45" 5.00 4.76 35 8.45 32°16'20" 15.00 4.34 36 145.27 15°14'38" 546.00 73.06 37 6.57 62°45'40" 6.00 3.63 39 48.54 47°08'30" 59.00 25.74 40 7.58 72°24'13" 6.00 4.39 41 7.24 69°	22	16.32	1°37'05"	578.00	8.16
25 7.15 68°17'57" 6.00 4.07 26 7.29 69°34'31" 6.00 4.17 27 8.14 93°16'33" 5.00 5.29 28 16.81 19°20'39" 49.79 8.49 29 7.85 90°00'00" 5.00 5.00 30 30.03 18°00'57" 95.51 15.14 31 28.55 17°02'21" 96.00 14.38 32 8.15 93°22'29" 5.00 5.30 33 15.45 42°09'46" 21.00 8.10 34 7.61 87°09'45" 5.00 4.76 35 8.45 32°16'20" 15.00 4.34 36 145.27 15°14'38" 546.00 73.06 37 6.57 62°45'40" 6.00 3.63 39 48.54 47°08'30" 59.00 25.74 40 7.58 72°24'13" 6.00 4.39 41 7.24	23	30.21	86°32'55"	20.00	18.83
26 7.29 69°34'31" 6.00 4.17 27 8.14 93°16'33" 5.00 5.29 28 16.81 19°20'39" 49.79 8.49 29 7.85 90°00'00" 5.00 5.00 30 30.03 18°00'57" 95.51 15.14 31 28.55 17°02'21" 96.00 14.38 32 8.15 93°22'29" 5.00 5.30 33 15.45 42°09'46" 21.00 8.10 34 7.61 87°09'45" 5.00 4.76 35 8.45 32°16'20" 15.00 4.34 36 145.27 15°14'38" 546.00 73.06 37 6.57 62°45'40" 6.00 3.63 39 48.54 47°08'30" 59.00 25.74 40 7.58 72°24'13" 6.00 4.13 42 37.57 86°06'05" 25.00 23.35 43 50.72 5°01'41" 578.00 25.38 44 6.64	24	82.18	51°44'31"	91.00	44.13
27 8.14 93°16'33" 5.00 5.29 28 16.81 19°20'39" 49.79 8.49 29 7.85 90°00'00" 5.00 5.00 30 30.03 18°00'57" 95.51 15.14 31 28.55 17°02'21" 96.00 14.38 32 8.15 93°22'29" 5.00 5.30 33 15.45 42°09'46" 21.00 8.10 34 7.61 87°09'45" 5.00 4.76 35 8.45 32°16'20" 15.00 4.34 36 145.27 15°14'38" 546.00 73.06 37 6.57 62°45'40" 6.00 3.63 39 48.54 47°08'30" 59.00 25.74 40 7.58 72°24'13" 6.00 4.39 41 7.24 69°07'04" 6.00 4.13 42 37.57 86°06'05" 25.00 23.35 43 50.72 5°01'41" 578.00 25.38 44 6.64	25	7.15	68°17'57"	6.00	4.07
28 16.81 19°20'39" 49.79 8.49 29 7.85 90°00'00" 5.00 5.00 30 30.03 18°00'57" 95.51 15.14 31 28.55 17°02'21" 96.00 14.38 32 8.15 93°22'29" 5.00 5.30 33 15.45 42°09'46" 21.00 8.10 34 7.61 87°09'45" 5.00 4.76 35 8.45 32°16'20" 15.00 4.34 36 145.27 15°14'38" 546.00 73.06 37 6.57 62°45'40" 6.00 3.63 39 48.54 47°08'30" 59.00 25.74 40 7.58 72°24'13" 6.00 4.39 41 7.24 69°07'04" 6.00 4.13 42 37.57 86°06'05" 25.00 23.35 43 50.72 5°01'41" 578.00 25.38 44 6.64 63°23'48" 6.00 3.71	26	7.29	69°34'31"	6.00	4.17
29 7.85 90°00'00" 5.00 5.00 30 30.03 18°00'57" 95.51 15.14 31 28.55 17°02'21" 96.00 14.38 32 8.15 93°22'29" 5.00 5.30 33 15.45 42°09'46" 21.00 8.10 34 7.61 87°09'45" 5.00 4.76 35 8.45 32°16'20" 15.00 4.34 36 145.27 15°14'38" 546.00 73.06 37 6.57 62°45'40" 6.00 3.63 39 48.54 47°08'30" 59.00 25.74 40 7.58 72°24'13" 6.00 4.39 41 7.24 69°07'04" 6.00 4.13 42 37.57 86°06'05" 25.00 23.35 43 50.72 5°01'41" 578.00 25.38 44 6.64 63°23'48" 6.00 3.71	27	8.14	93°16'33"	5.00	5.29
30 30.03 18°00'57" 95.51 15.14 31 28.55 17°02'21" 96.00 14.38 32 8.15 93°22'29" 5.00 5.30 33 15.45 42°09'46" 21.00 8.10 34 7.61 87°09'45" 5.00 4.76 35 8.45 32°16'20" 15.00 4.34 36 145.27 15°14'38" 546.00 73.06 37 6.57 62°45'40" 6.00 3.63 38 6.52 62°17'45" 6.00 3.63 39 48.54 47°08'30" 59.00 25.74 40 7.58 72°24'13" 6.00 4.39 41 7.24 69°07'04" 6.00 4.13 42 37.57 86°06'05" 25.00 23.35 43 50.72 5°01'41" 578.00 25.38 44 6.64 63°23'48" 6.00 3.71	28	16.81	19°20'39"	49.79	8.49
31 28.55 17°02'21" 96.00 14.38 32 8.15 93°22'29" 5.00 5.30 33 15.45 42°09'46" 21.00 8.10 34 7.61 87°09'45" 5.00 4.76 35 8.45 32°16'20" 15.00 4.34 36 145.27 15°14'38" 546.00 73.06 37 6.57 62°45'40" 6.00 3.66 38 6.52 62°17'45" 6.00 3.63 39 48.54 47°08'30" 59.00 25.74 40 7.58 72°24'13" 6.00 4.39 41 7.24 69°07'04" 6.00 4.13 42 37.57 86°06'05" 25.00 23.35 43 50.72 5°01'41" 578.00 25.38 44 6.64 63°23'48" 6.00 3.71	29	7.85	90°00'00"	5.00	5.00
32 8.15 93°22'29" 5.00 5.30 33 15.45 42°09'46" 21.00 8.10 34 7.61 87°09'45" 5.00 4.76 35 8.45 32°16'20" 15.00 4.34 36 145.27 15°14'38" 546.00 73.06 37 6.57 62°45'40" 6.00 3.63 38 6.52 62°17'45" 6.00 3.63 39 48.54 47°08'30" 59.00 25.74 40 7.58 72°24'13" 6.00 4.39 41 7.24 69°07'04" 6.00 4.13 42 37.57 86°06'05" 25.00 23.35 43 50.72 5°01'41" 578.00 25.38 44 6.64 63°23'48" 6.00 3.71	30	30.03	18°00'57"	95.51	15.14
33 15.45 42°09'46" 21.00 8.10 34 7.61 87°09'45" 5.00 4.76 35 8.45 32°16'20" 15.00 4.34 36 145.27 15°14'38" 546.00 73.06 37 6.57 62°45'40" 6.00 3.66 38 6.52 62°17'45" 6.00 3.63 39 48.54 47°08'30" 59.00 25.74 40 7.58 72°24'13" 6.00 4.39 41 7.24 69°07'04" 6.00 4.13 42 37.57 86°06'05" 25.00 23.35 43 50.72 5°01'41" 578.00 25.38 44 6.64 63°23'48" 6.00 3.71	31	28.55	17°02'21"	96.00	14.38
34 7.61 87°09'45" 5.00 4.76 35 8.45 32°16'20" 15.00 4.34 36 145.27 15°14'38" 546.00 73.06 37 6.57 62°45'40" 6.00 3.66 38 6.52 62°17'45" 6.00 3.63 39 48.54 47°08'30" 59.00 25.74 40 7.58 72°24'13" 6.00 4.39 41 7.24 69°07'04" 6.00 4.13 42 37.57 86°06'05" 25.00 23.35 43 50.72 5°01'41" 578.00 25.38 44 6.64 63°23'48" 6.00 3.71	32	8.15	93°22'29"	5.00	5.30
35 8.45 32°16'20" 15.00 4.34 36 145.27 15°14'38" 546.00 73.06 37 6.57 62°45'40" 6.00 3.66 38 6.52 62°17'45" 6.00 3.63 39 48.54 47°08'30" 59.00 25.74 40 7.58 72°24'13" 6.00 4.39 41 7.24 69°07'04" 6.00 4.13 42 37.57 86°06'05" 25.00 23.35 43 50.72 5°01'41" 578.00 25.38 44 6.64 63°23'48" 6.00 3.71	33	15.45	42°09'46"	21.00	8.10
36 145.27 15°14'38" 546.00 73.06 37 6.57 62°45'40" 6.00 3.66 38 6.52 62°17'45" 6.00 3.63 39 48.54 47°08'30" 59.00 25.74 40 7.58 72°24'13" 6.00 4.39 41 7.24 69°07'04" 6.00 4.13 42 37.57 86°06'05" 25.00 23.35 43 50.72 5°01'41" 578.00 25.38 44 6.64 63°23'48" 6.00 3.71	34	7.61	87°09'45"	5.00	4.76
37 6.57 62°45'40" 6.00 3.66 38 6.52 62°17'45" 6.00 3.63 39 48.54 47°08'30" 59.00 25.74 40 7.58 72°24'13" 6.00 4.39 41 7.24 69°07'04" 6.00 4.13 42 37.57 86°06'05" 25.00 23.35 43 50.72 5°01'41" 578.00 25.38 44 6.64 63°23'48" 6.00 3.71	35	8.45	32°16'20"	15.00	4.34
38 6.52 62°17'45" 6.00 3.63 39 48.54 47°08'30" 59.00 25.74 40 7.58 72°24'13" 6.00 4.39 41 7.24 69°07'04" 6.00 4.13 42 37.57 86°06'05" 25.00 23.35 43 50.72 5°01'41" 578.00 25.38 44 6.64 63°23'48" 6.00 3.71	36	145.27	15°14'38"	546.00	73.06
39 48.54 47°08'30" 59.00 25.74 40 7.58 72°24'13" 6.00 4.39 41 7.24 69°07'04" 6.00 4.13 42 37.57 86°06'05" 25.00 23.35 43 50.72 5°01'41" 578.00 25.38 44 6.64 63°23'48" 6.00 3.71	37	6.57	62°45'40"	6.00	3.66
40 7.58 72°24'13" 6.00 4.39 41 7.24 69°07'04" 6.00 4.13 42 37.57 86°06'05" 25.00 23.35 43 50.72 5°01'41" 578.00 25.38 44 6.64 63°23'48" 6.00 3.71	38	6.52	62°17'45"	6.00	3.63
41 7.24 69°07'04" 6.00 4.13 42 37.57 86°06'05" 25.00 23.35 43 50.72 5°01'41" 578.00 25.38 44 6.64 63°23'48" 6.00 3.71	39	48.54	47°08'30"	59.00	25.74
42 37.57 86°06'05" 25.00 23.35 43 50.72 5°01'41" 578.00 25.38 44 6.64 63°23'48" 6.00 3.71	40	7.58	72°24'13"	6.00	4.39
43 50.72 5°01'41" 578.00 25.38 44 6.64 63°23'48" 6.00 3.71	41	7.24	69°07'04"	6.00	4.13
44 6.64 63°23'48" 6.00 3.71	42	37.57	86°06'05"	25.00	23.35
	43	50.72	5°01'41"	578.00	25.38
45 7.12 67°57'05" 6.00 4.04	44	6.64	63°23'48"	6.00	3.71
	45	7.12	67°57'05"	6.00	4.04

		CURVE TABLE		
CURVE#	LENGTH	DIRECTION/DELTA	RADIUS	TANGENT
46	15.71	90°00'00"	10.00	10.00
47	39.61	45°23'05"	50.00	20.91
51	12.57	90°00'00"	8.00	8.00
52	87.75	55°51'53"	90.00	47.72
53	50.45	30°06'27"	96.00	25.82
54	27.05	24°28'04"	63.35	13.74
55	14.04	23°39'43"	34.00	7.12
56	6.28	60°00'00"	6.00	3.46
57	6.28	60°00'00"	6.00	3.46
58	6.24	59°36'31"	6.00	3.44
59	6.60	63°00'02"	6.00	3.68
60	4.71	90°00'00"	3.00	3.00
61	4.71	90°00'00"	3.00	3.00

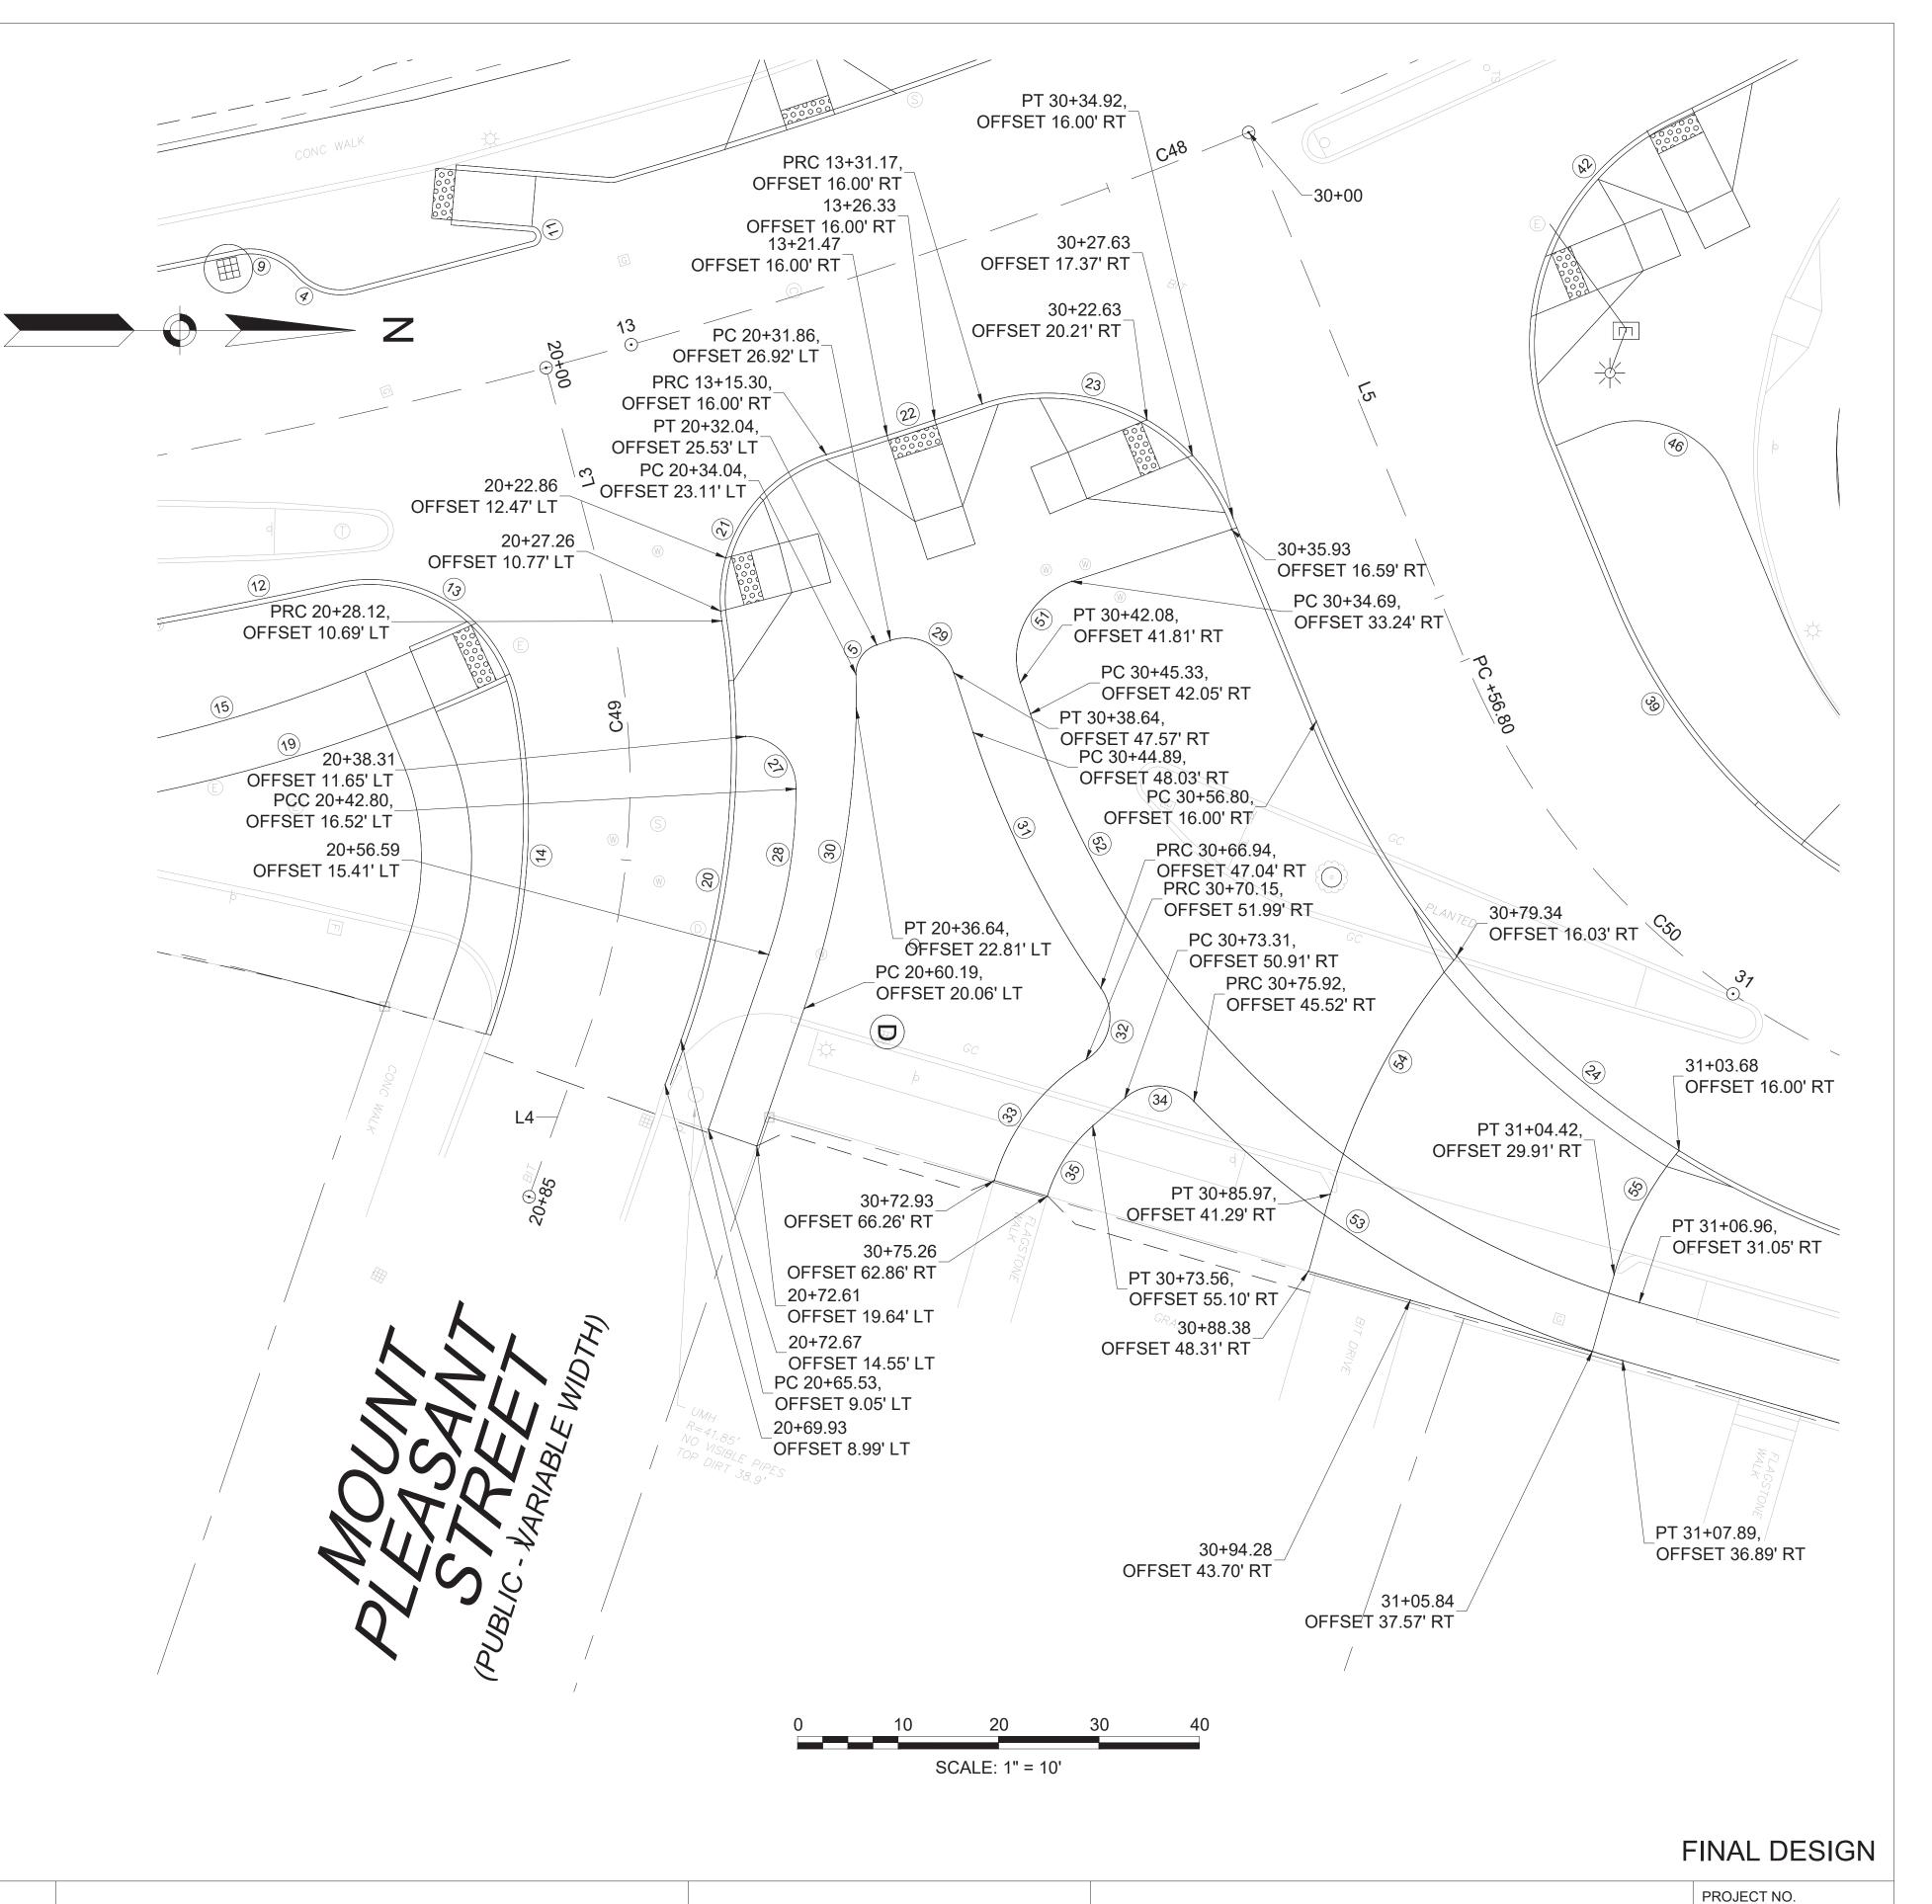

PROFESSIONAL CERTIFICATION

I HEREBY CERTIFY THAT THESE PLANS
WERE PREPARED OR APPROVED BY
ME, AND THAT I AM A DULY LICENSED
PROFESSIONAL ENGINEER UNDER THE
LAWS OF THE COMMONWEALTH OF
MASSACHUSETTS,
LICENSE NO. 49208,

EXPIRATION DATE:6/30/2020.



	ALL I	DRAV		REUSE OF DOCUMENTS INSTRUMENTS OF PROFESSIONAL SERVICE FOR THIS PROJECT. SE OR ALTERATION IS AT THE USER'S SOLE RISK.		
DSGN	CBK					
DR	RPI					
CHK	KMF					
APVD	ELG	NO	DATE	REVISION	BY	APVD


2 OLIVER STREET, SUITE 305 BOSTON, MA 02109 PHONE: 617.619.9910 FAX: 301.927.2800 www.tooledesign.com

MCCALL MIDDLE SCHOOL		DATE
TRAFFIC IMPROVEMENT PROJECT		
	MAIN STREET AT WASHINGTON STREET CURB TIE PLAN	DRAWING NO.
		SHEET NO.

60139

3/18/2020

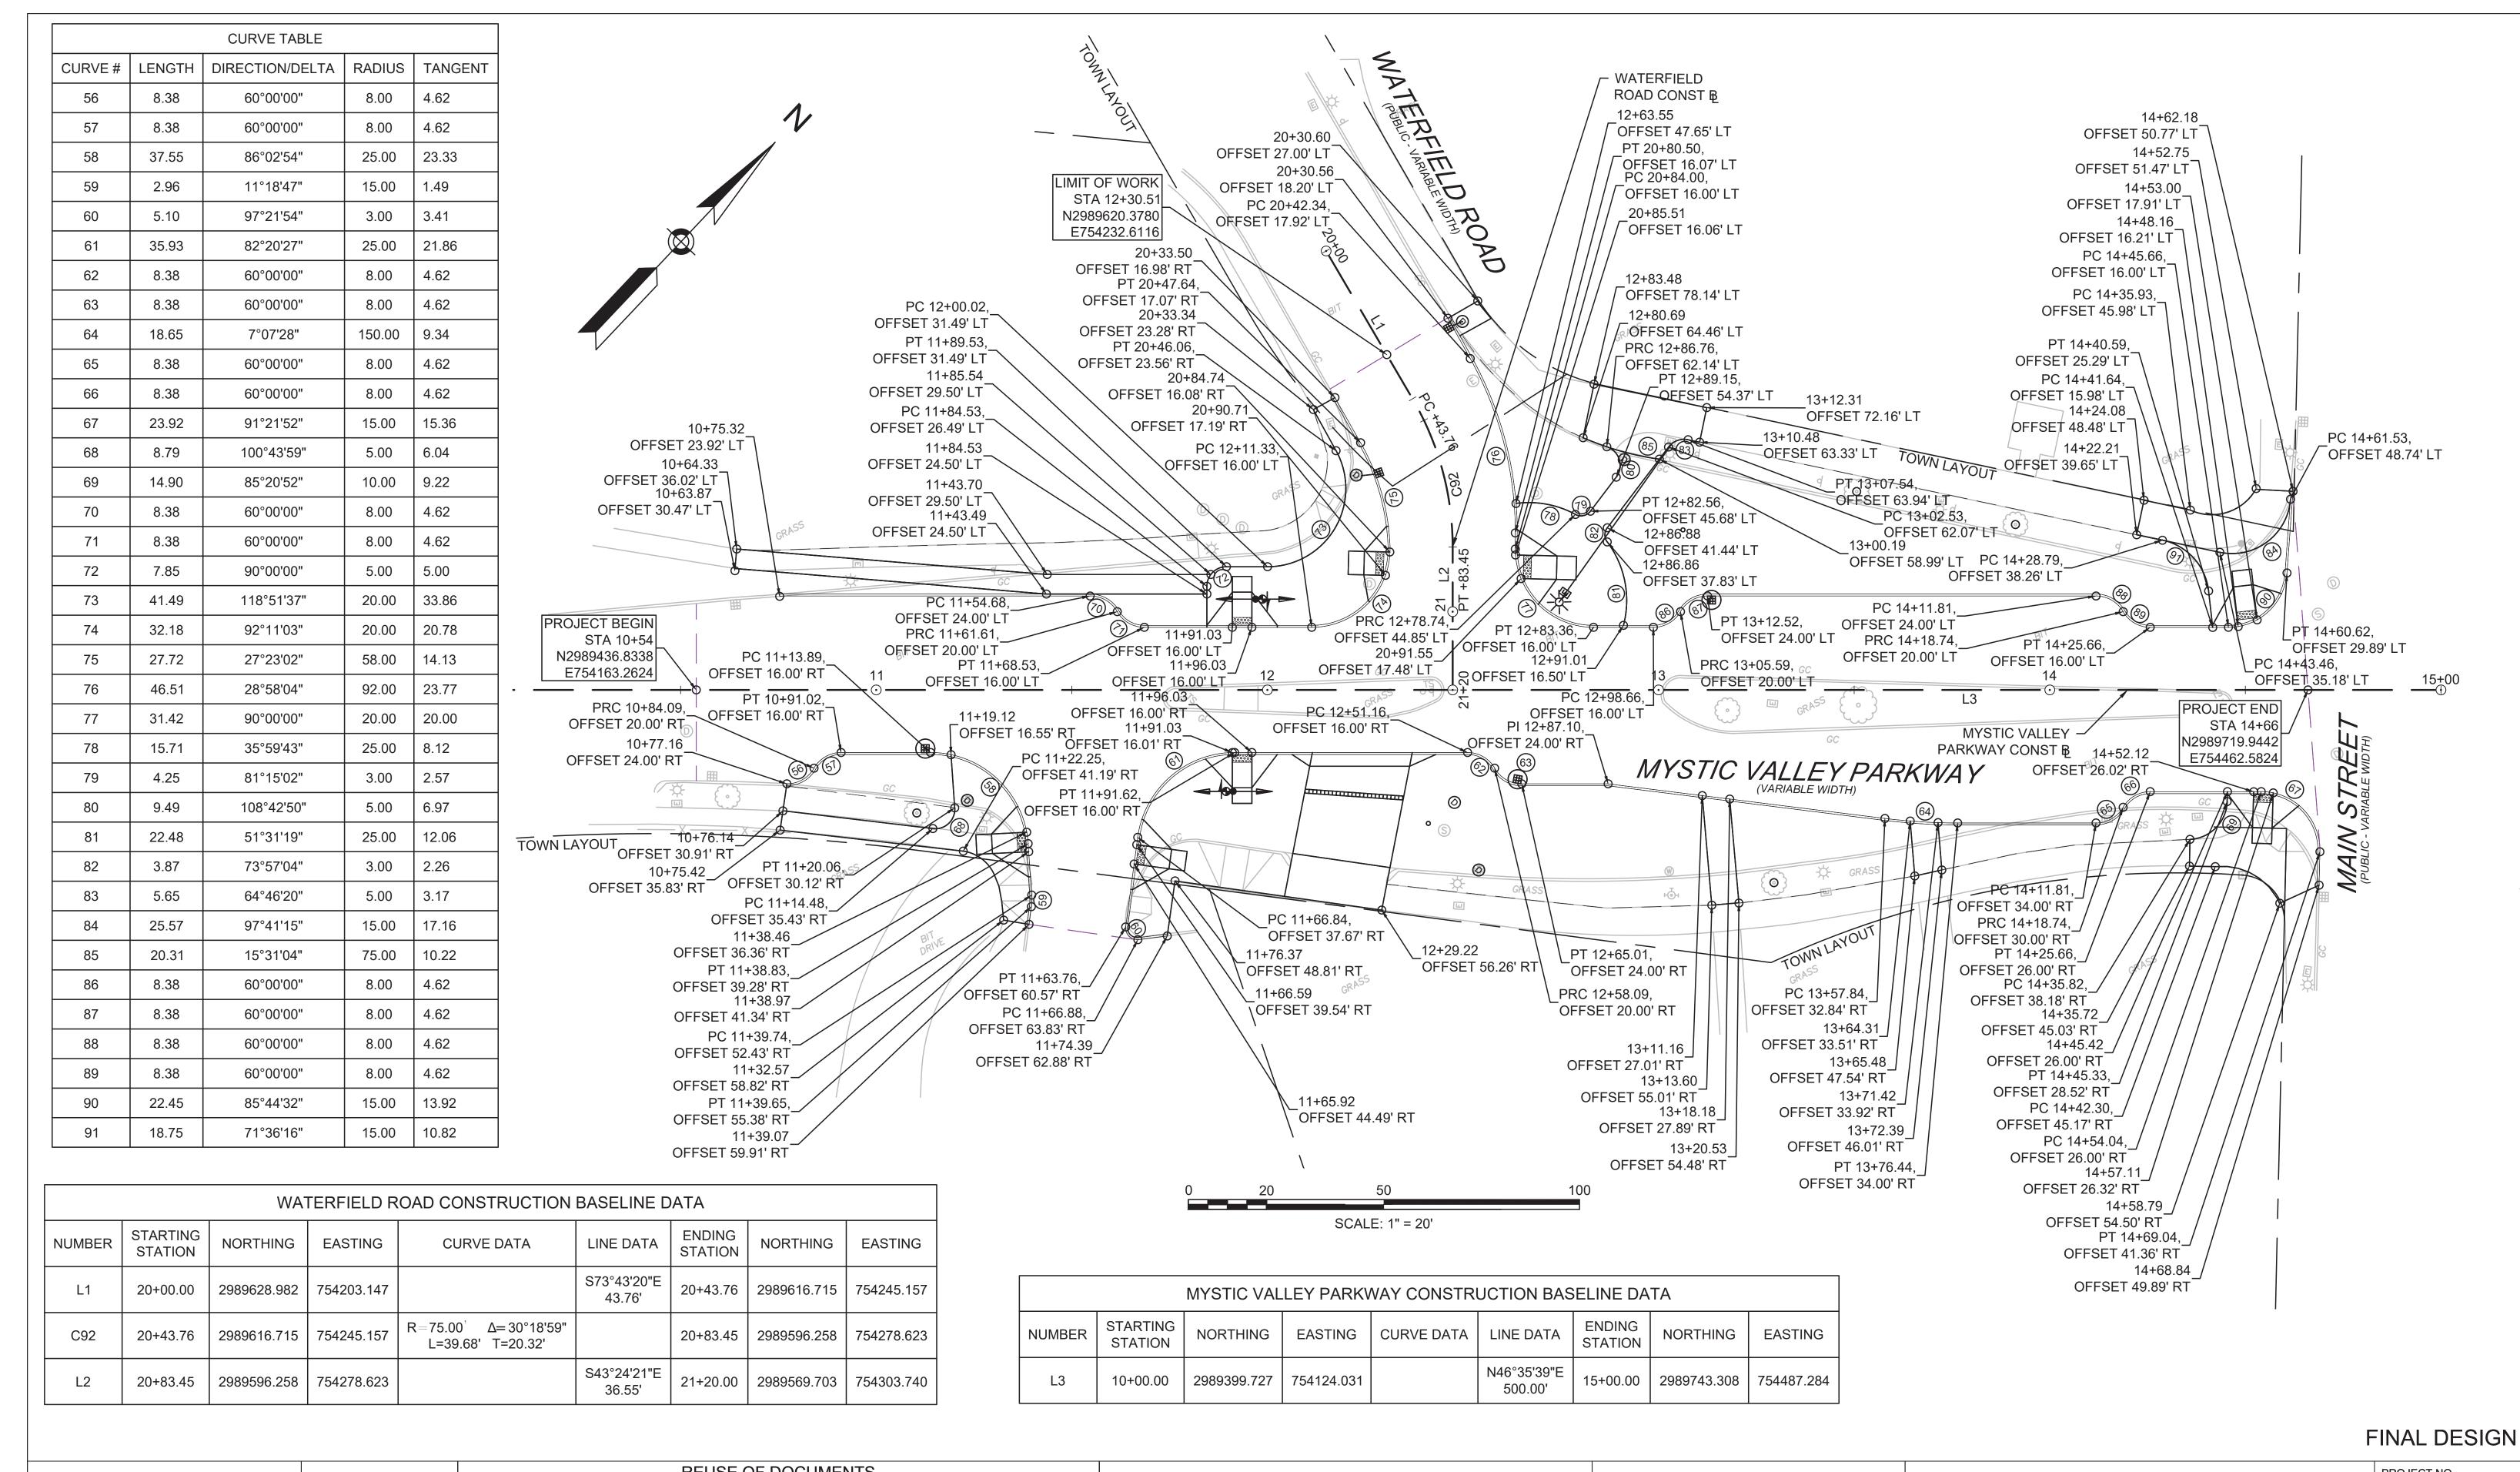CT.02



PROFESSIONAL CERTIFICATION

I HEREBY CERTIFY THAT THESE PLANS
WERE PREPARED OR APPROVED BY
ME, AND THAT I AM A DULY LICENSED
PROFESSIONAL ENGINEER UNDER THE
LAWS OF THE COMMONWEALTH OF
MASSACHUSETTS,
LICENSE NO. 49208,
EXPIRATION DATE:6/30/2020.



	REUSE OF DOCUMENTS ALL DRAWINGS ARE INSTRUMENTS OF PROFESSIONAL SERVICE FOR THIS PROJECT. REUSE OR ALTERATION IS AT THE USER'S SOLE RISK.										
L. C.	DSGN	СВК									
	DR	RPI									
	CHK	KMF									
	APVD	ELG	NO.	DATE	REVISION	BY	APVD				

2 OLIVER STREET, SUITE 305 BOSTON, MA 02109 PHONE: 617.619.9910 FAX: 301.927.2800 www.tooledesign.com

MCCALL MIDDLE SCHOOL
TRAFFIC IMPROVEMENT PROJECT

MYSTIC VALLEY PARKWAY

CURB TIE PLAN


SHEET NO.

PROJECT NO.

60139

3/18/2020

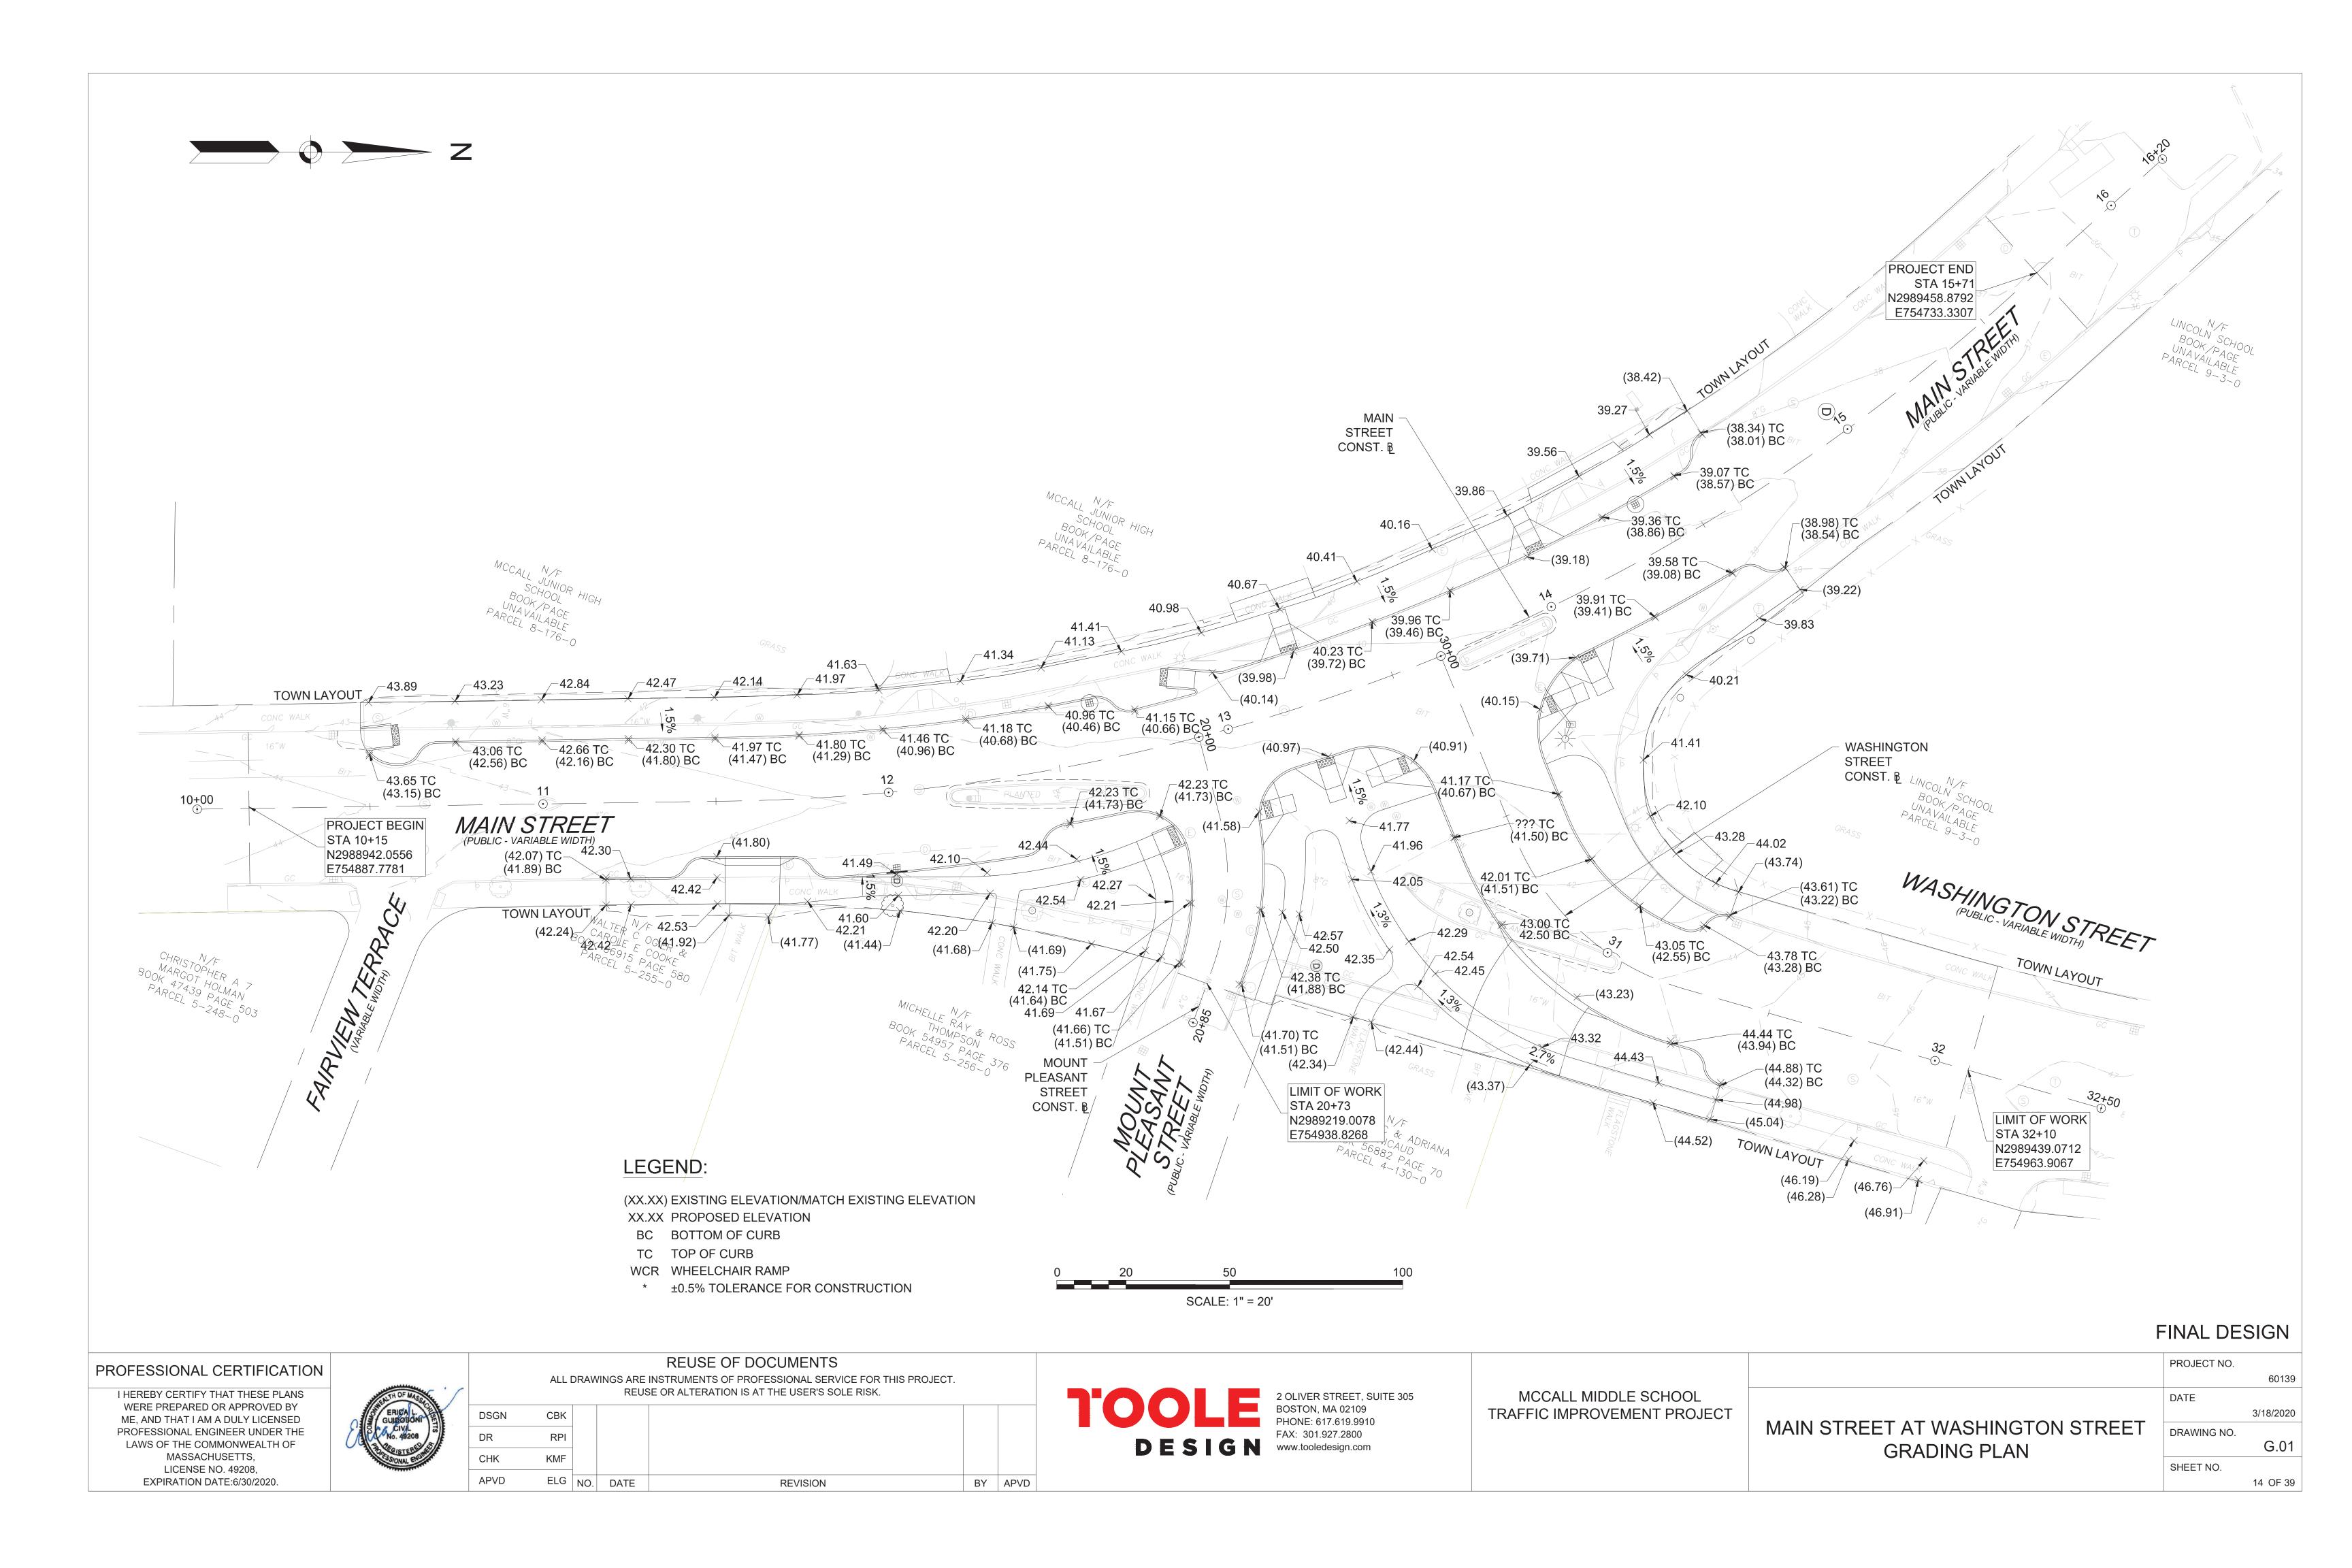CT.03





I HEREBY CERTIFY THAT THESE PLANS
WERE PREPARED OR APPROVED BY
ME, AND THAT I AM A DULY LICENSED
PROFESSIONAL ENGINEER UNDER THE
LAWS OF THE COMMONWEALTH OF
MASSACHUSETTS,
LICENSE NO. 49208,
EXPIRATION DATE:6/30/2020.



ALL DRAWINGS ARE INSTRUMENTS OF PROFESSIONAL SERVICE FOR THIS PROJECT. REUSE OR ALTERATION IS AT THE USER'S SOLE RISK. DSGN CBK DR RPI CHK KMF APVD ELG NO. DATE REVISION BY APVD

2 OLIVER STREET, SUITE 305 BOSTON, MA 02109 PHONE: 617.619.9910 FAX: 301.927.2800 www.tooledesign.com

MCCALL MIDDLE SCHOOL TRAFFIC IMPROVEMENT PROJECT

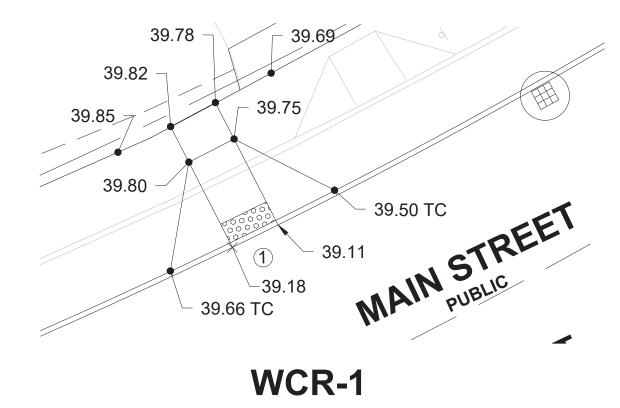
MYSTIC VALLEY PARKWAY
GRADING PLAN

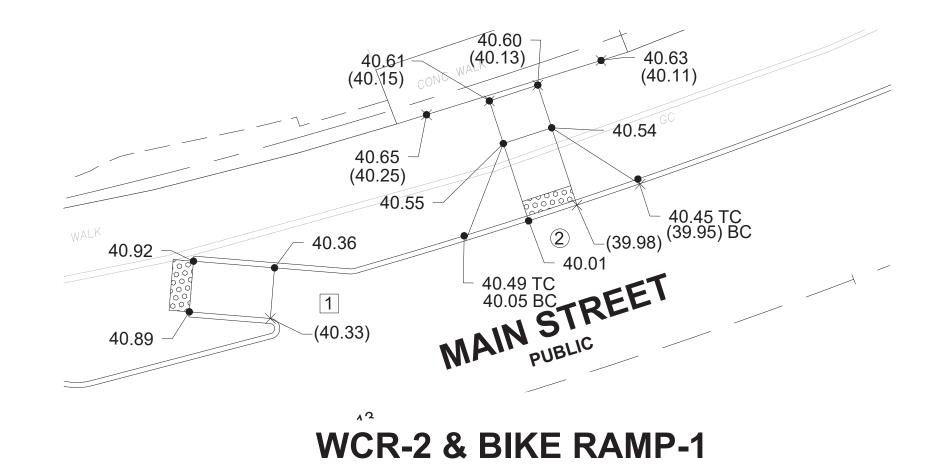
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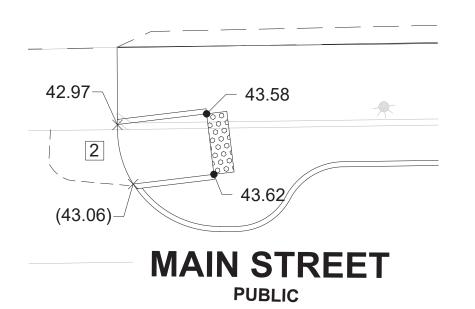
3/18/2020

G.01

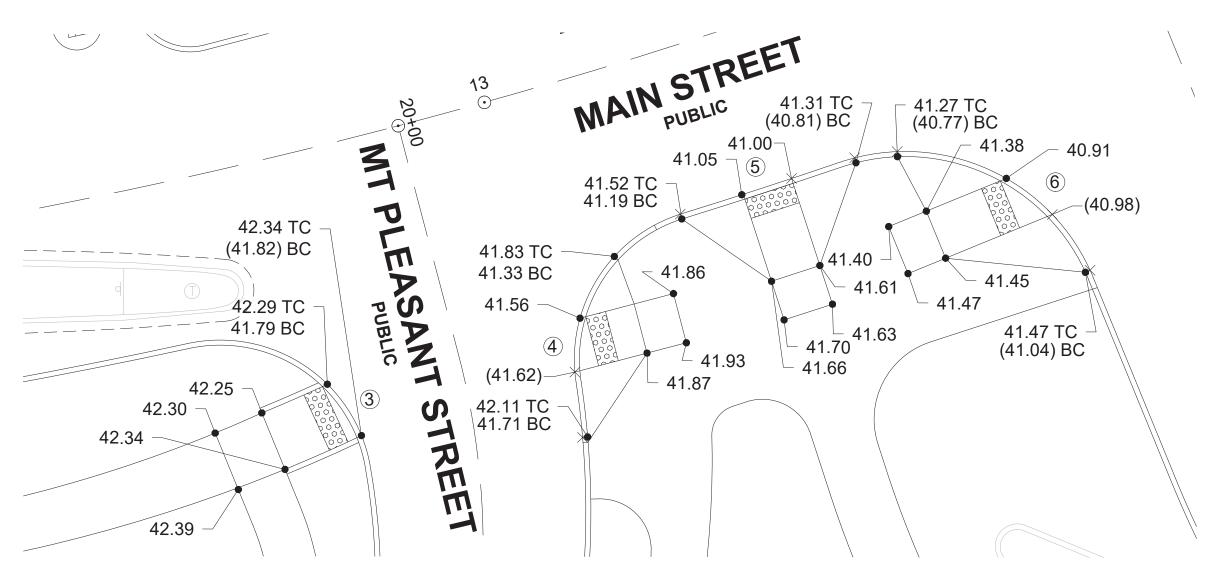









BIKE RAMP-2



WCR-3 & WCR-4 & WCR-5 & WCR-6

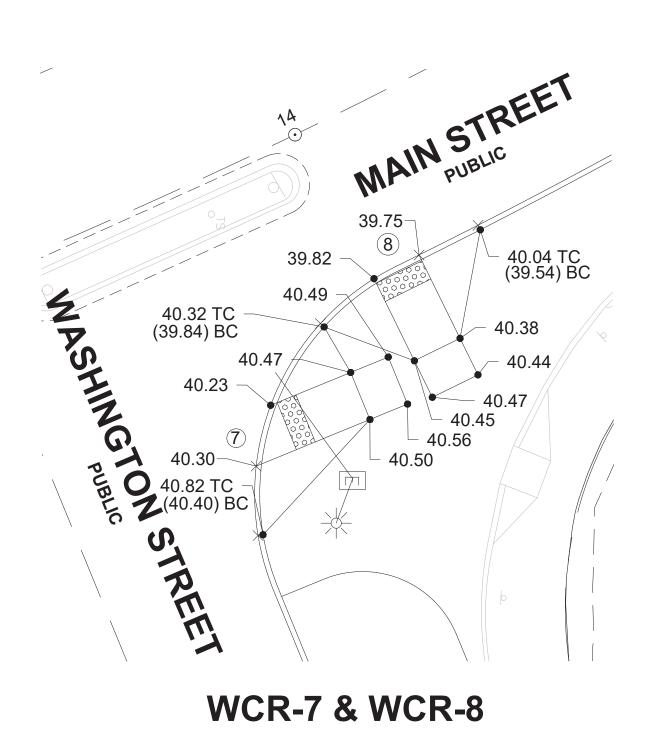

NOTES:

- 1. MAXIMUM CURB REVEAL TO BE 7".
- 2. IN INSTANCES WHERE AN EXISTING MANHOLE, HANDHOLE OR OTHER SURFACE STRUCTURES THAT CANNOT BE REMOVED OR RESET IS WITHIN THE PROPOSED OR EXISTING CURB RAMP, THE STRUCTURE SHALL BE CAREFULLY ADJUSTED SUCH THAT THE TOPMOST SURFACE/COVER SHALL BE FLUSH WITH THE CURB RAMP SURFACE.
- 3. THE ROADWAY CROSS SLOPE SHALL NOT EXCEED 1.5%*, INCLUDING, BUT NOT LIMITED TO , TRANSITION RAMP CROSS SLOPE, LEVEL LANDING AND THE PROPOSED RAMP OPENING.
- 4. A CURB RAMP RUNNING SLOPE SHALL NOT EXCEED 7.5%*.
- 5. PROPOSED ELEVATION AT GUTTER LINE INDICATES CHANGE OF ELEVATION FROM EXISTING ROADWAY IN ORDER TO MAINTAIN POSITIVE DRAINAGE. ADJACENT SAWCUT LINE TO MATCH EXISTING ELEVATION.
- 6. SEE SHEET 38 FOR CURB RAMP DIMENSIONS AND STATION/OFFSET REFERENCES.

LEGEND:

(XX.XX) EXISTING ELEVATION

XX.XX PROPOSED ELEVATION

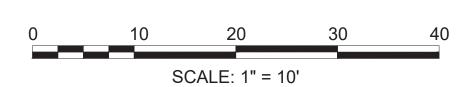
BC BOTTOM OF CURB

TC TOP OF CURB

±0.5% TOLERANCE FOR CONSTRUCTION

WHEELCHAIR RAMP IDENTIFIER

BIKE RAMP IDENTIFIER




FINAL DESIGN

PROFESSIONAL CERTIFICATION

I HEREBY CERTIFY THAT THESE PLANS
WERE PREPARED OR APPROVED BY
ME, AND THAT I AM A DULY LICENSED
PROFESSIONAL ENGINEER UNDER THE
LAWS OF THE COMMONWEALTH OF
MASSACHUSETTS,
LICENSE NO. 49208,

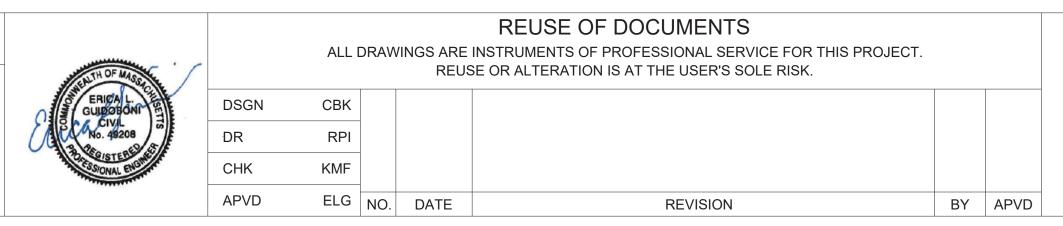EXPIRATION DATE:6/30/2020.





MCCALL MIDDLE SCHOOL TRAFFIC IMPROVEMENT PROJECT

MAIN STREET AT WASHINGTON STREET WHEELCHAIR RAMP GRADING PLAN

PROJECT NO.

60139

DATE

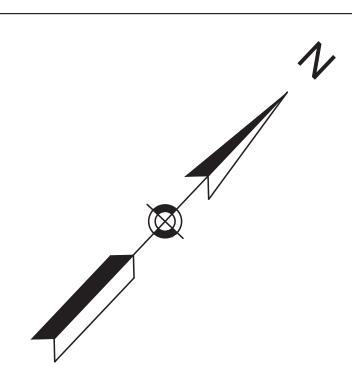
3/18/2020

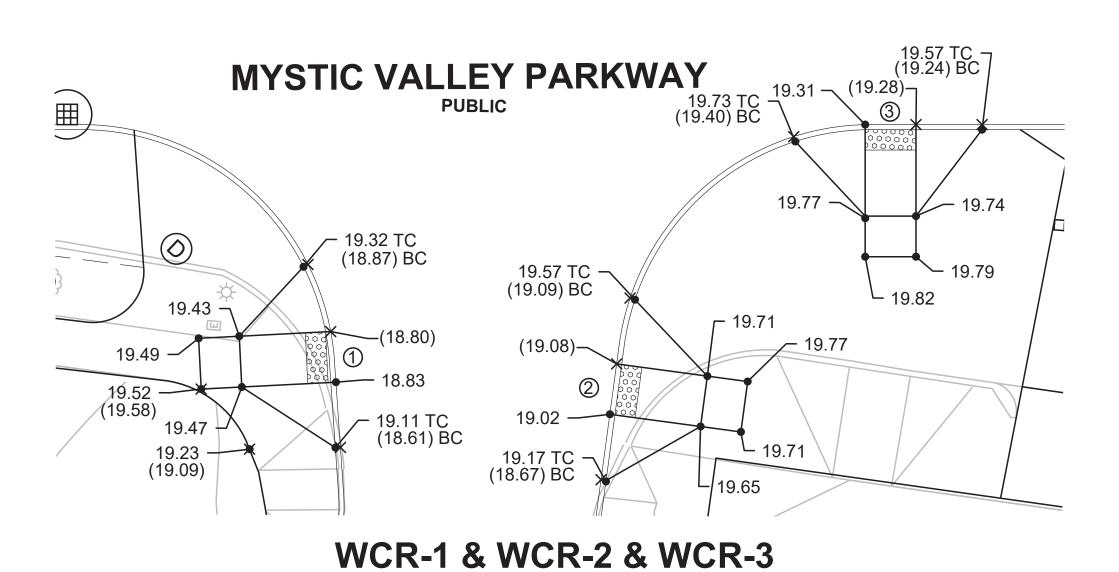
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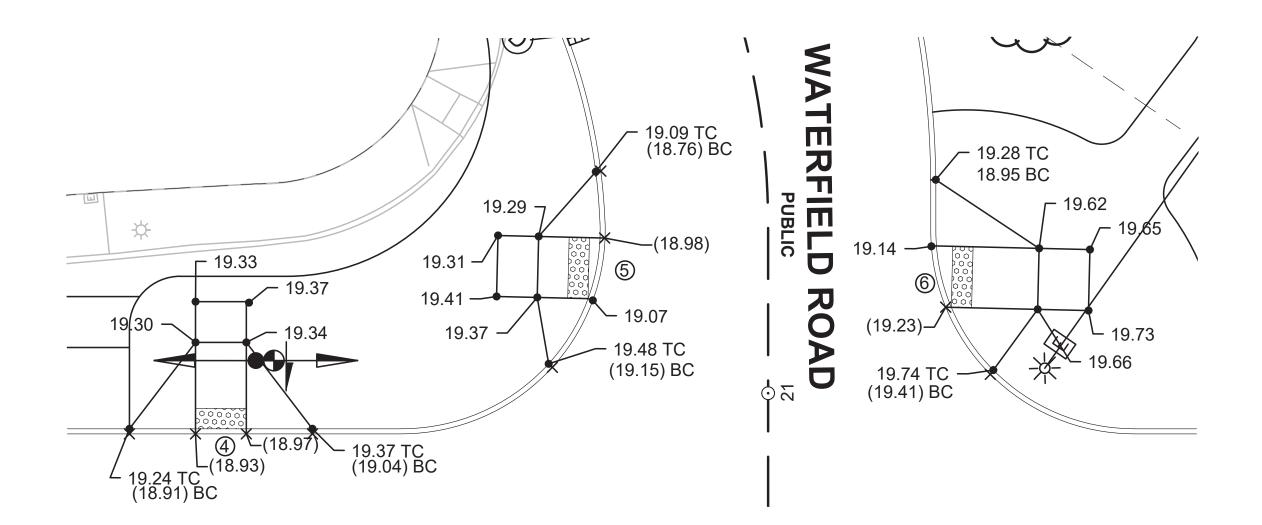
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SHEET NO.


16 OF 39







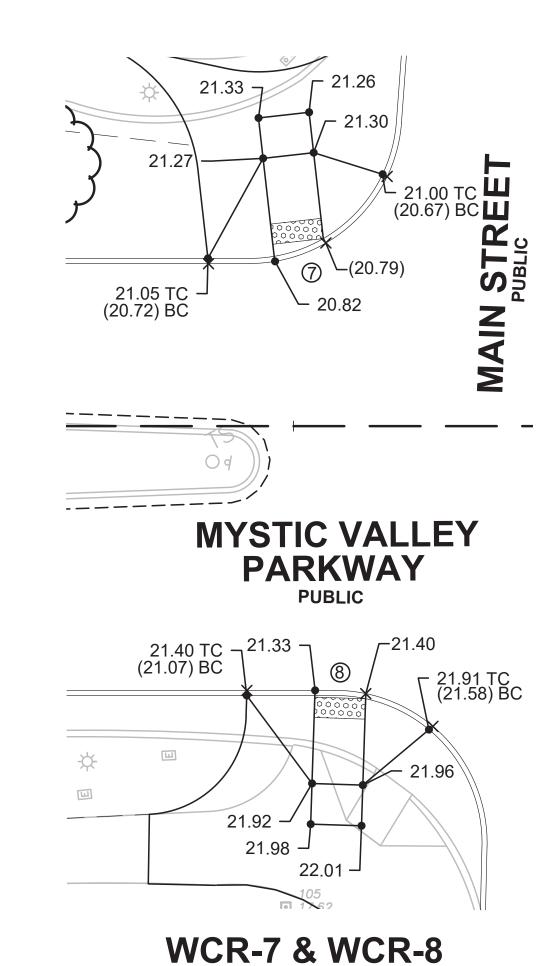WCR-4 & WCR-5 & WCR-6



NOTES:

- 1. MAXIMUM CURB REVEAL TO BE 7".
- THE TOPMOST SURFACE/COVER SHALL BE FLUSH WITH THE CURB RAMP SURFACE.
- 3. THE ROADWAY CROSS SLOPE SHALL NOT EXCEED 1.5%*, INCLUDING, BUT NOT LIMITED TO , TRANSITION RAMP CROSS SLOPE, LEVEL LANDING AND THE PROPOSED RAMP
- 4. A CURB RAMP RUNNING SLOPE SHALL NOT EXCEED 7.5%*.
- 5. PROPOSED ELEVATION AT GUTTER LINE INDICATES CHANGE OF ELEVATION FROM EXISTING ROADWAY IN ORDER TO MAINTAIN POSITIVE DRAINAGE. ADJACENT SAWCUT LINE TO MATCH EXISTING ELEVATION.
- 6. SEE SHEET 38 FOR CURB RAMP DIMENSIONS AND STATION/OFFSET REFERENCES.

LEGEND:

(XX.XX) EXISTING ELEVATION

XX.XX PROPOSED ELEVATION BC BOTTOM OF CURB

- TC TOP OF CURB
- * ±0.5% TOLERANCE FOR CONSTRUCTION
- # WHEELCHAIR RAMP IDENTIFIER

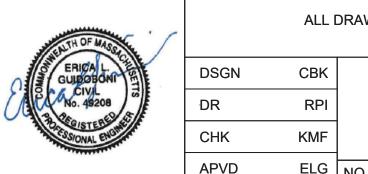


FINAL DESIGN

PROFESSIONAL CERTIFICATION

I HEREBY CERTIFY THAT THESE PLANS WERE PREPARED OR APPROVED BY ME, AND THAT I AM A DULY LICENSED PROFESSIONAL ENGINEER UNDER THE LAWS OF THE COMMONWEALTH OF MASSACHUSETTS, LICENSE NO. 49208,

EXPIRATION DATE:6/30/2020.



	ALL I	DRAW		REUSE OF DOCUMENTS INSTRUMENTS OF PROFESSIONAL SERVICE FOR THIS PROJECT. SE OR ALTERATION IS AT THE USER'S SOLE RISK.			
DSGN	CBK						
DR	RPI						
CHK	KMF						
APVD	ELG	NO.	DATE	REVISION	BY	APVD	

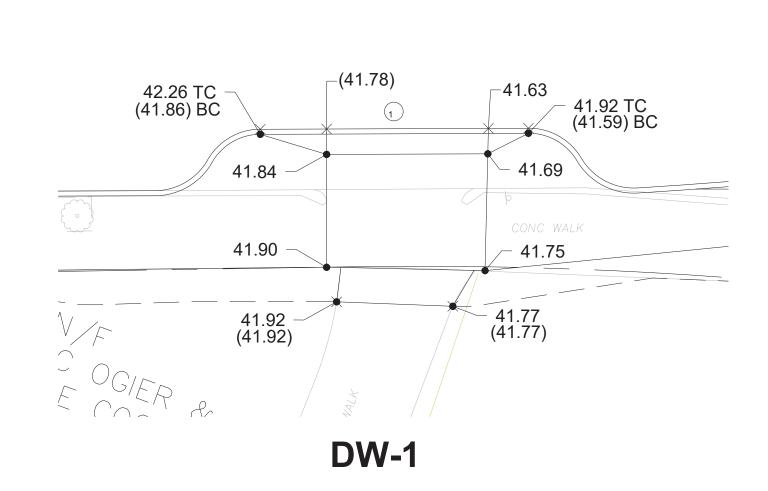


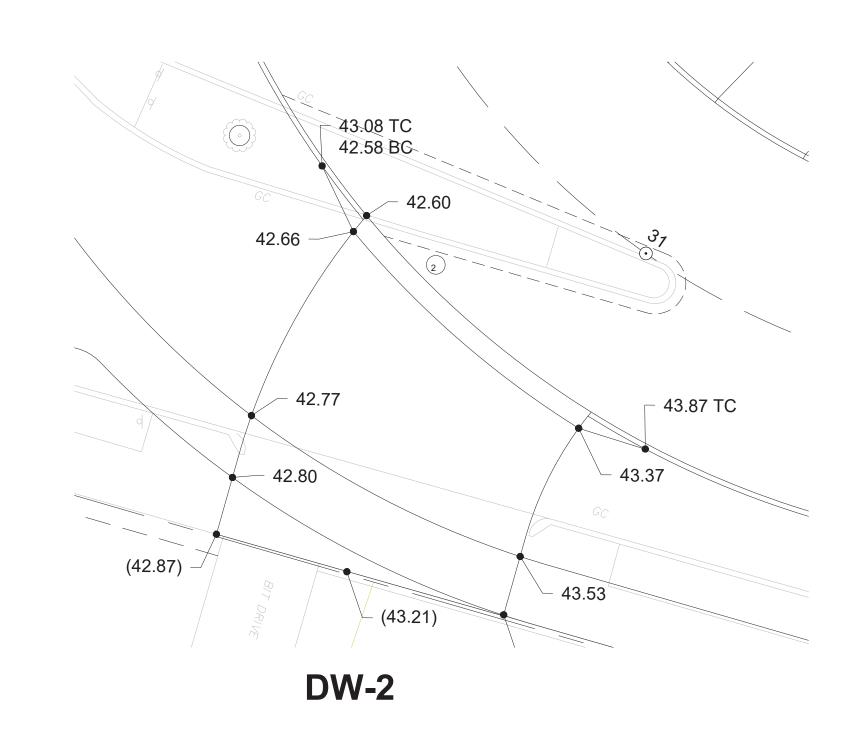
MCCALL MIDDLE SCHOOL TRAFFIC IMPROVEMENT PROJECT

MYSTIC VALLEY PARKWAY WHEELCHAIR RAMP GRADING PLAN

PROJECT NO.
60139
DATE
3/18/2020
DRAWING NO.
WCR.02
SHEET NO.
17 OF 39







NOTES:

- 1. MAXIMUM CURB REVEAL TO BE 7".
- IN INSTANCES WHERE AN EXISTING MANHOLE, HANDHOLE OR OTHER SURFACE STRUCTURES THAT CANNOT BE REMOVED OR RESET IS WITHIN THE PROPOSED OR EXISTING DRIVEWAY, THE STRUCTURE SHALL BE CAREFULLY ADJUSTED SUCH THAT THE TOPMOST SURFACE/COVER SHALL BE FLUSH WITH THE DRIVEWAY SURFACE.
- 3. A DRIVEWAY RUNNING SLOPE SHALL NOT EXCEED 15%*.
- 4. PROPOSED ELEVATION AT GUTTER LINE INDICATES CHANGE OF ELEVATION FROM EXISTING ROADWAY IN ORDER TO MAINTAIN POSITIVE DRAINAGE. ADJACENT SAWCUT LINE TO MATCH EXISTING ELEVATION.
- 5. SEE SHEET 39 FOR DRIVEWAY DIMENSIONS AND STATION/OFFSET REFERENCES.

LEGEND:

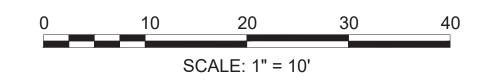
(XX.XX) EXISTING ELEVATION
XX.XX PROPOSED ELEVATION

BC BOTTOM OF CURB

TC TOP OF CURB

* ±0.5% TOLERANCE FOR CONSTRUCTION

DRIVEWAY IDENTIFIER



FINAL DESIGN

60139

3/18/2020

DW.01

18 OF 39

PROJECT NO.

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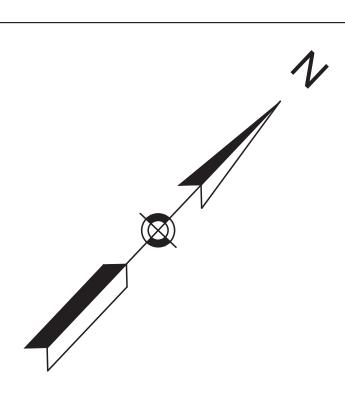



				REUSE OF DOCUMENTS		
	ALL I	DRAW		INSTRUMENTS OF PROFESSIONAL SERVICE FOR THIS PROJECT. SE OR ALTERATION IS AT THE USER'S SOLE RISK.		
DSGN	CBK					
DR	RPI					
CHK	KMF					
APVD	ELG	NO.	DATE	REVISION	BY	APVD



MCCALL MIDDLE SCHOOL
TRAFFIC IMPROVEMENT PROJECT

	DATE
MAIN STREET AT WASHINGTON STREET DRIVEWAY GRADING PLAN	DRAWING NO
	SHEET NO.



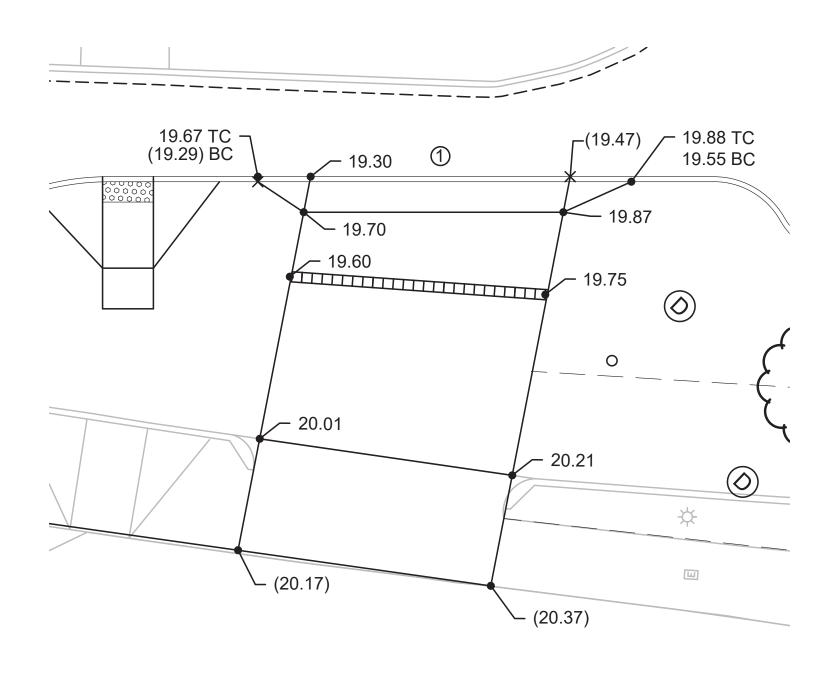

DW-1

NOTES:

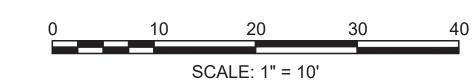
- MAXIMUM CURB REVEAL TO BE 7".
- 2. IN INSTANCES WHERE AN EXISTING MANHOLE, HANDHOLE OR OTHER SURFACE STRUCTURES THAT CANNOT BE REMOVED OR RESET IS WITHIN THE PROPOSED OR EXISTING DRIVEWAY, THE STRUCTURE SHALL BE CAREFULLY ADJUSTED SUCH THAT THE TOPMOST SURFACE/COVER SHALL BE FLUSH WITH THE DRIVEWAY SURFACE.
- 3. A DRIVEWAY RUNNING SLOPE SHALL NOT EXCEED 15%*.
- 4. PROPOSED ELEVATION AT GUTTER LINE INDICATES CHANGE OF ELEVATION FROM EXISTING ROADWAY IN ORDER TO MAINTAIN POSITIVE DRAINAGE. ADJACENT SAWCUT LINE TO MATCH EXISTING ELEVATION.
- 5. SEE SHEET 39 FOR DRIVEWAY DIMENSIONS AND STATION/OFFSET REFERENCES.

LEGEND:

(XX.XX) EXISTING ELEVATION

XX.XX PROPOSED ELEVATION

- BC BOTTOM OF CURB
- TC TOP OF CURB
- * ±0.5% TOLERANCE FOR CONSTRUCTION
- # DRIVEWAY IDENTIFIER



FINAL DESIGN


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LICENSE NO. 49208,

EXPIRATION DATE:6/30/2020.



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DSGN	СВК						
DR	RPI						
CHK	KMF						
APVD	ELG	NO.	DATE	REVISION	BY	APVD	

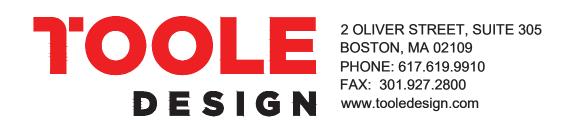



MCCALL MIDDLE SCHOOL
TRAFFIC IMPROVEMENT PROJEC

MYSTIC VALLEY PARKWAY
DRIVEWAY GRADING PLAN

	60139
DATE	
	3/18/2020
DRAWING NO.	
	DW.02
SHEET NO.	
	19 OF 39

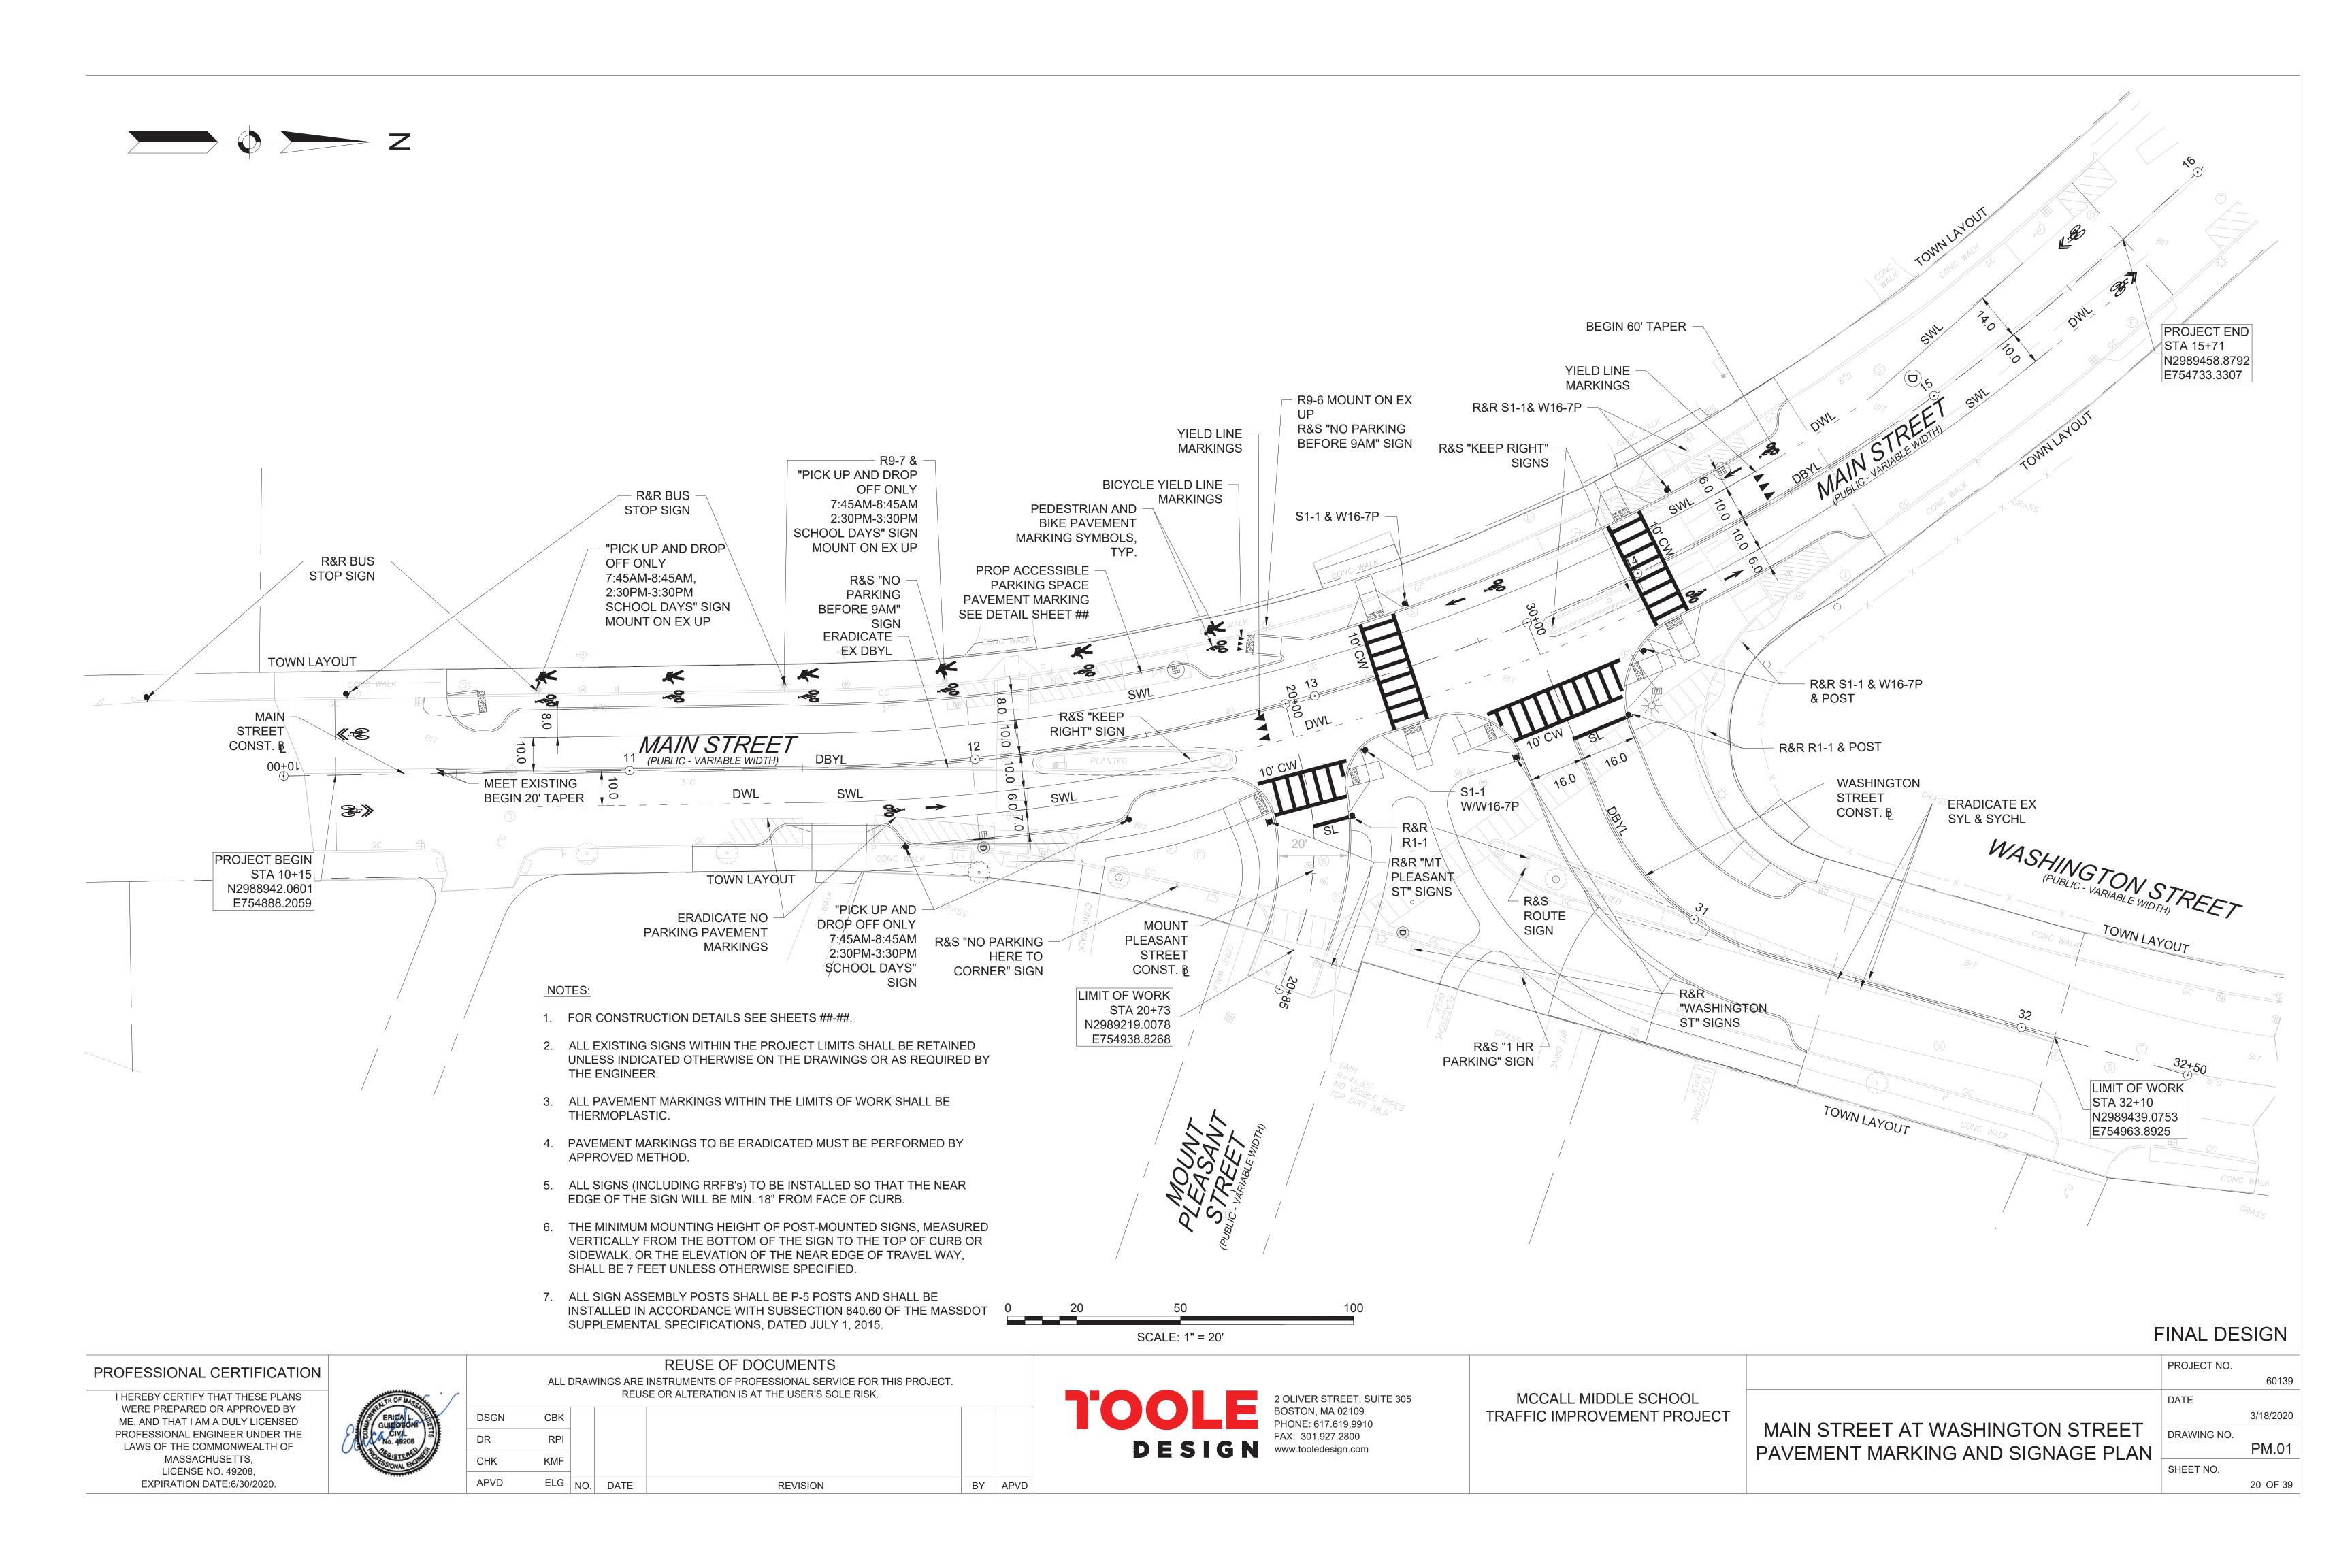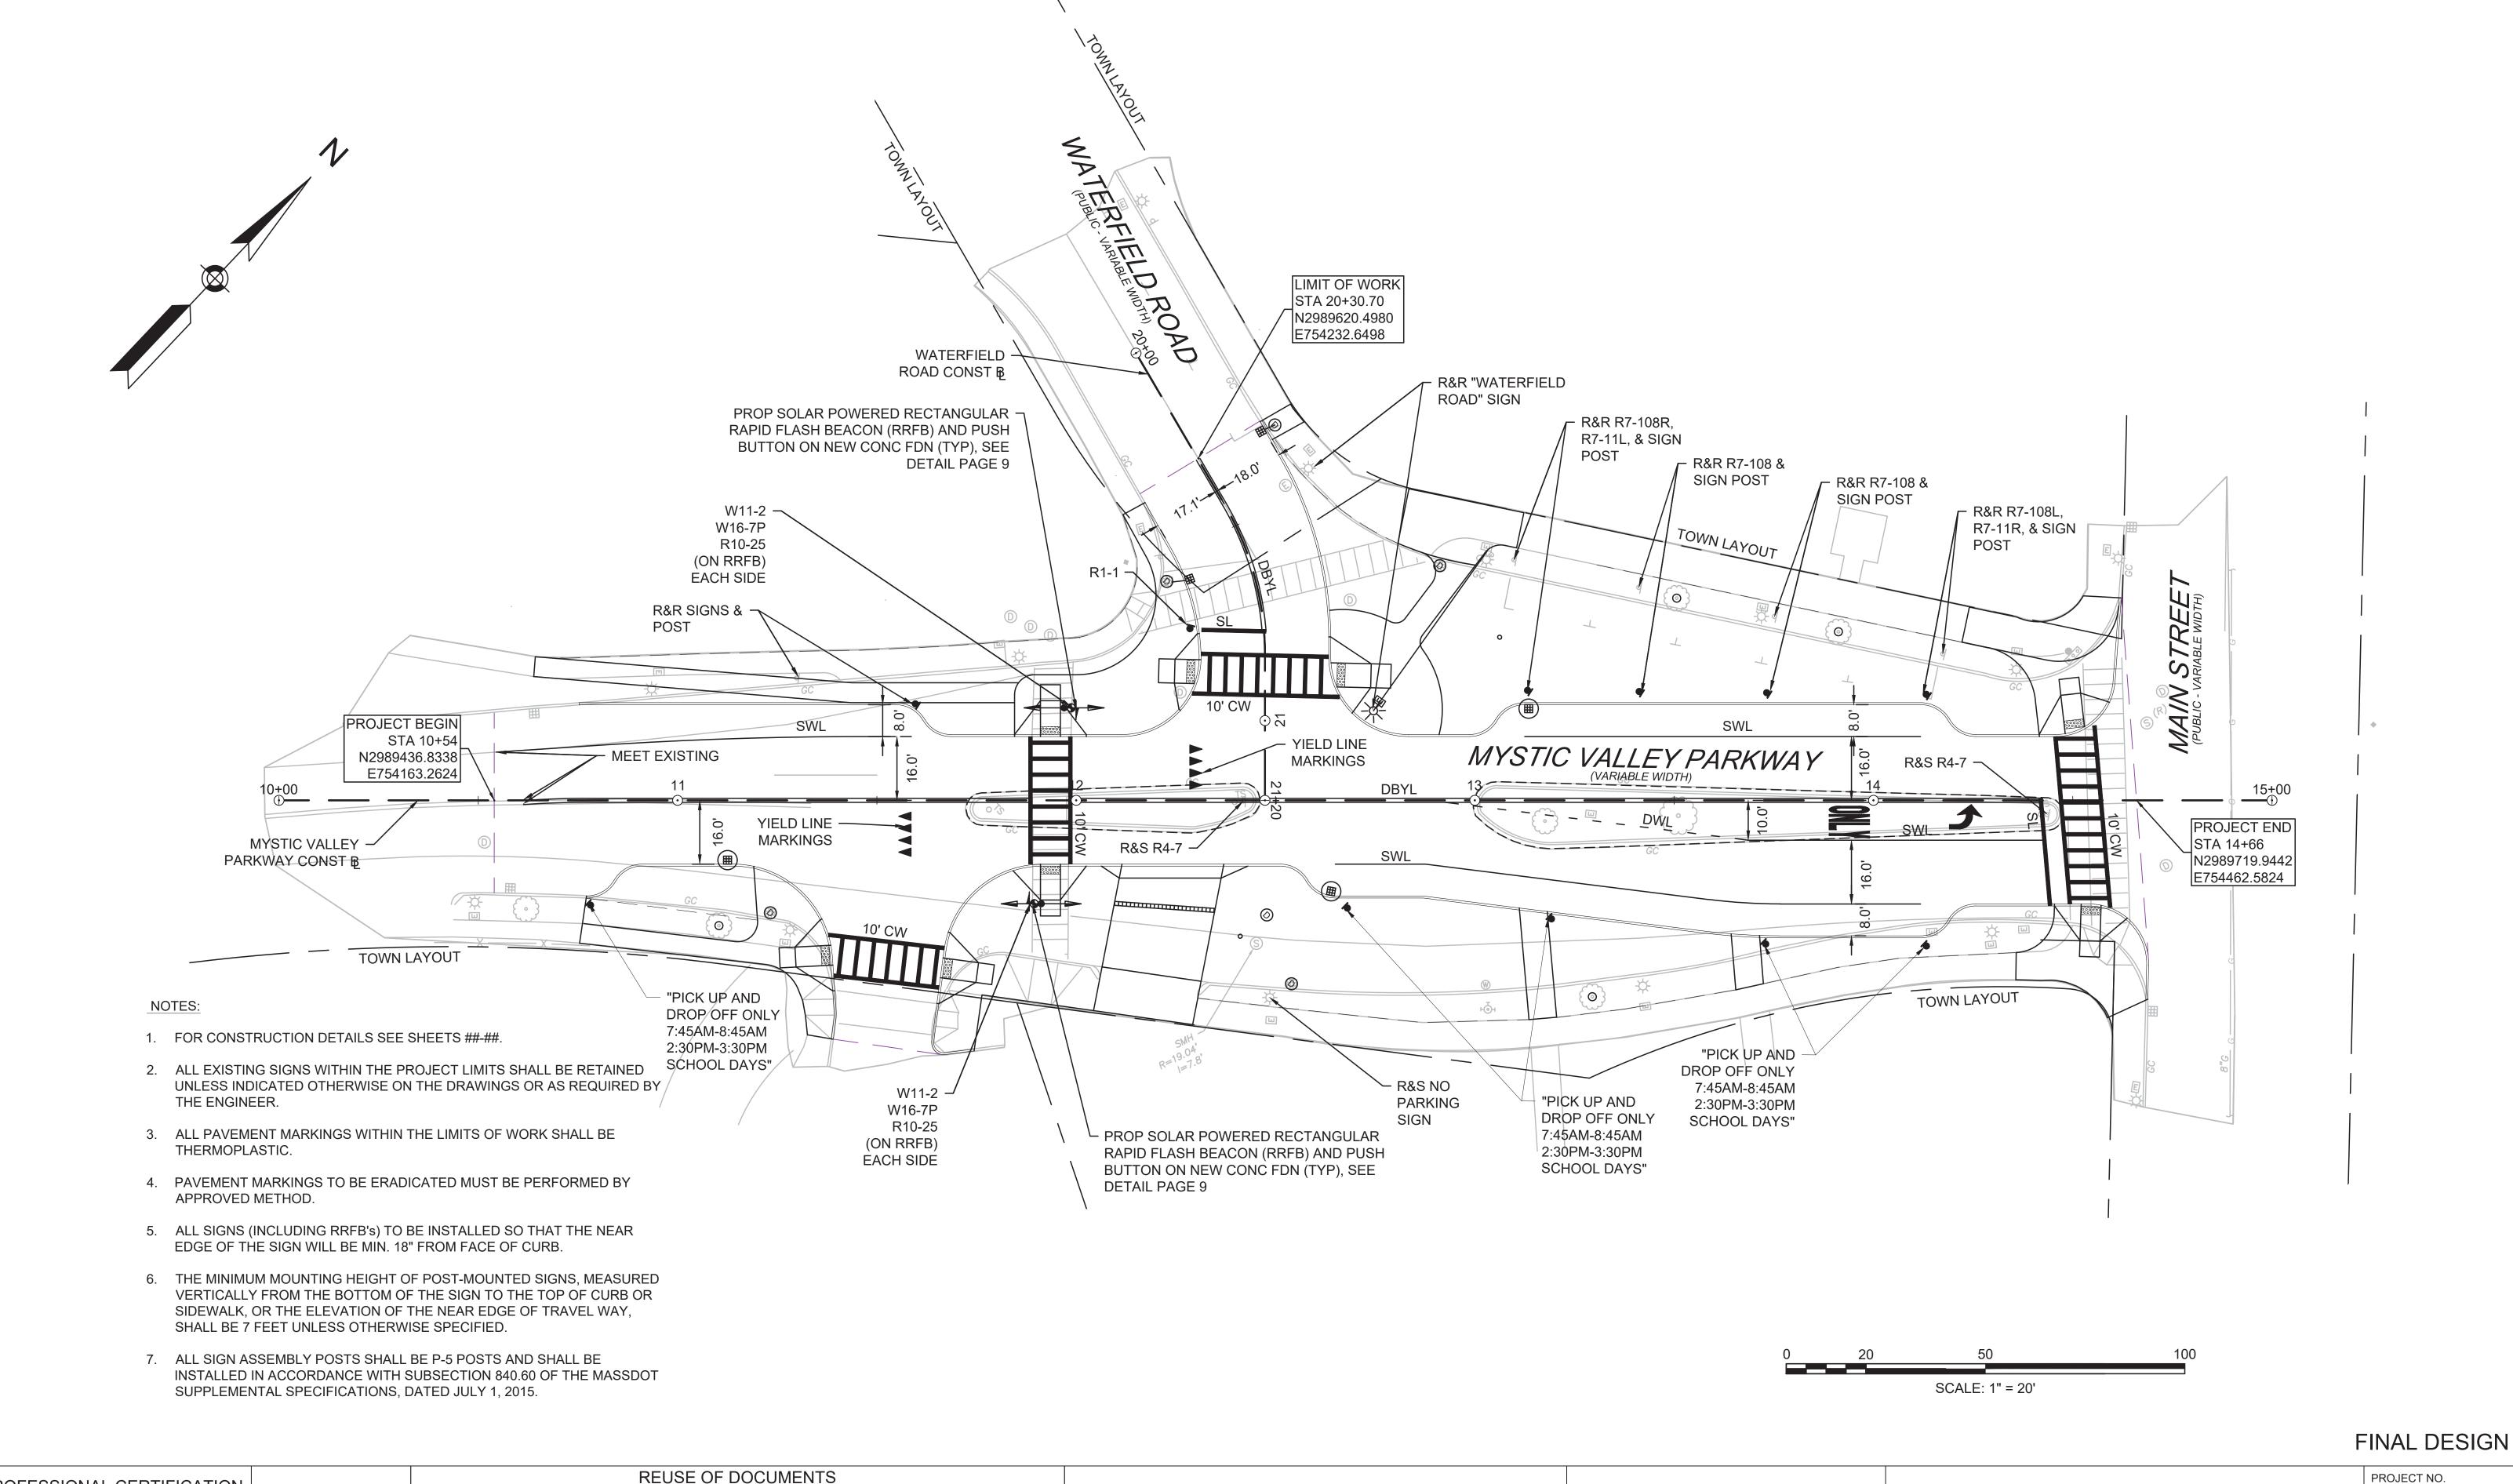PROJECT NO.





PROFESSIONAL CERTIFICATION

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DESIGN FAX: 301.927.2800 www.tooledesign.com

MCCALL MIDDLE SCHOOL TRAFFIC IMPROVEMENT PROJECT

MYSTIC VALLEY PARKWAY PAVEMENT MARKING AND SIGNAGE PLAN

60139 DATE 3/18/2020 DRAWING NO. PM.02 SHEET NO. 21 OF 39

	SIZE OF SIGN (in.)			TEXT DIMENSIONS (in.) NUMBER			COLOR*			POST SIZE	TOTAL		
ID NUMBER	WIDTH	HEIGHT	LEGEND	LETTER HEIGHT	VERTICAL SPACING	ARROW RTE. MKR.	OF SIGNS REQUIRED	BACKGROUND	LEGEND	BORDER	AND NUMBER REQUIRED	UNIT AREA (SF)	TOTAL AREA (SF)
R1-1	30	30	STOP	SEE MUTC	D STANDA	ARD DETAIL	1	RED	WHITE	WHITE	P-5 REQ'D	6.25	6.25
R9-6	12	18	YIELD TO PEDS				1	WHITE	BLACK	BLACK	MOUNT ON EX UP	1.50	1.50
R9-7	12	18	KEEP LEFT RIGHT				3	WHITE	BLACK	BLACK	MOUNT ON EX UP	1.50	4.50
R10-25	9	12	PUSH BUTTON TO TURN ON WARNING LIGHTS				4	WHITE	BLACK	BLACK	MOUNT 4 ON RRFB	0.75	3.00
R10-12	24	30	LEFT TURN YIELD ON GREEN				1	WHITE	BLACK	BLACK	MOUNT ON SIGNAL POST	5.00	3.00
S1-1	36	36	***				2	FYG	BLACK	BLACK	P-5 2 REQ'D	9.00	18.00
W11-2	30	30					4	FYG	BLACK	BLACK	MOUNT 4 ON RRFB, MOUNT 2 W/ S1-1	6.25	25.00
W16-7PL	24	12					6	FYG	BLACK	BLACK	MOUNT 4 ON RRFB, MOUNT 2 W/ S1-1	2.00	12.00
CUSTOM	12	18	PICK UP & DROP OFF ONLY 7:45AM - 8:45AM 2:30PM - 3:30PM school days				10	WHITE	RED	RED	P-5 10 REQ'D	1.50	15.00

SIGN SUMMARY NOTES:


- 1. FYG = FLUORESCENT YELLOW-GREEN
- 2. THE MINIMUM MOUNTING HEIGHT OF POST-MOUNTED SIGNS, MEASURED VERTICALLY FROM THE BOTTOM OF THE SIGN TO THE TOP OF CURB OR SIDEWALK, OR THE ELEVATION OF THE NEAR EDGE OF TRAVEL WAY, SHALL BE 7 FEET UNLESS OTHERWISE SPECIFIED.
- 3. ALL SIGN ASSEMBLY POSTS SHALL BE P-5 POSTS AND SHALL BE INSTALLED IN ACCORDANCE WITH SUBSECTION 840.60 OF THE MASSDOT SUPPLEMENTAL SPECIFICATIONS, DATED APRIL 1, 2019.

PROFESSIONAL CERTIFICATION

I HEREBY CERTIFY THAT THESE PLANS
WERE PREPARED OR APPROVED BY
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EXPIRATION DATE:6/30/2020.




REUSE OF DOCUMENTS ALL DRAWINGS ARE INSTRUMENTS OF PROFESSIONAL SERVICE FOR THIS PROJECT. REUSE OR ALTERATION IS AT THE USER'S SOLE RISK. DSGN CBK DR RPI CHK KMF APVD ELG NO. DATE REVISION BY APVD

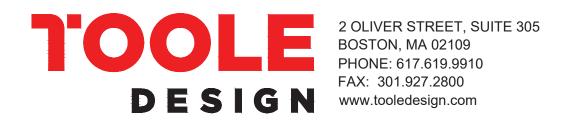

MCCALL MIDDLE SCHOOL	
TRAFFIC IMPROVEMENT PROJECT	
	SIGN

	PROJECT NO.	
		60139
	DATE	
		3/18/2020
	DRAWING NO.	
SIGN SUMMARY		SS.01
	SHEET NO.	
		22 OF 39

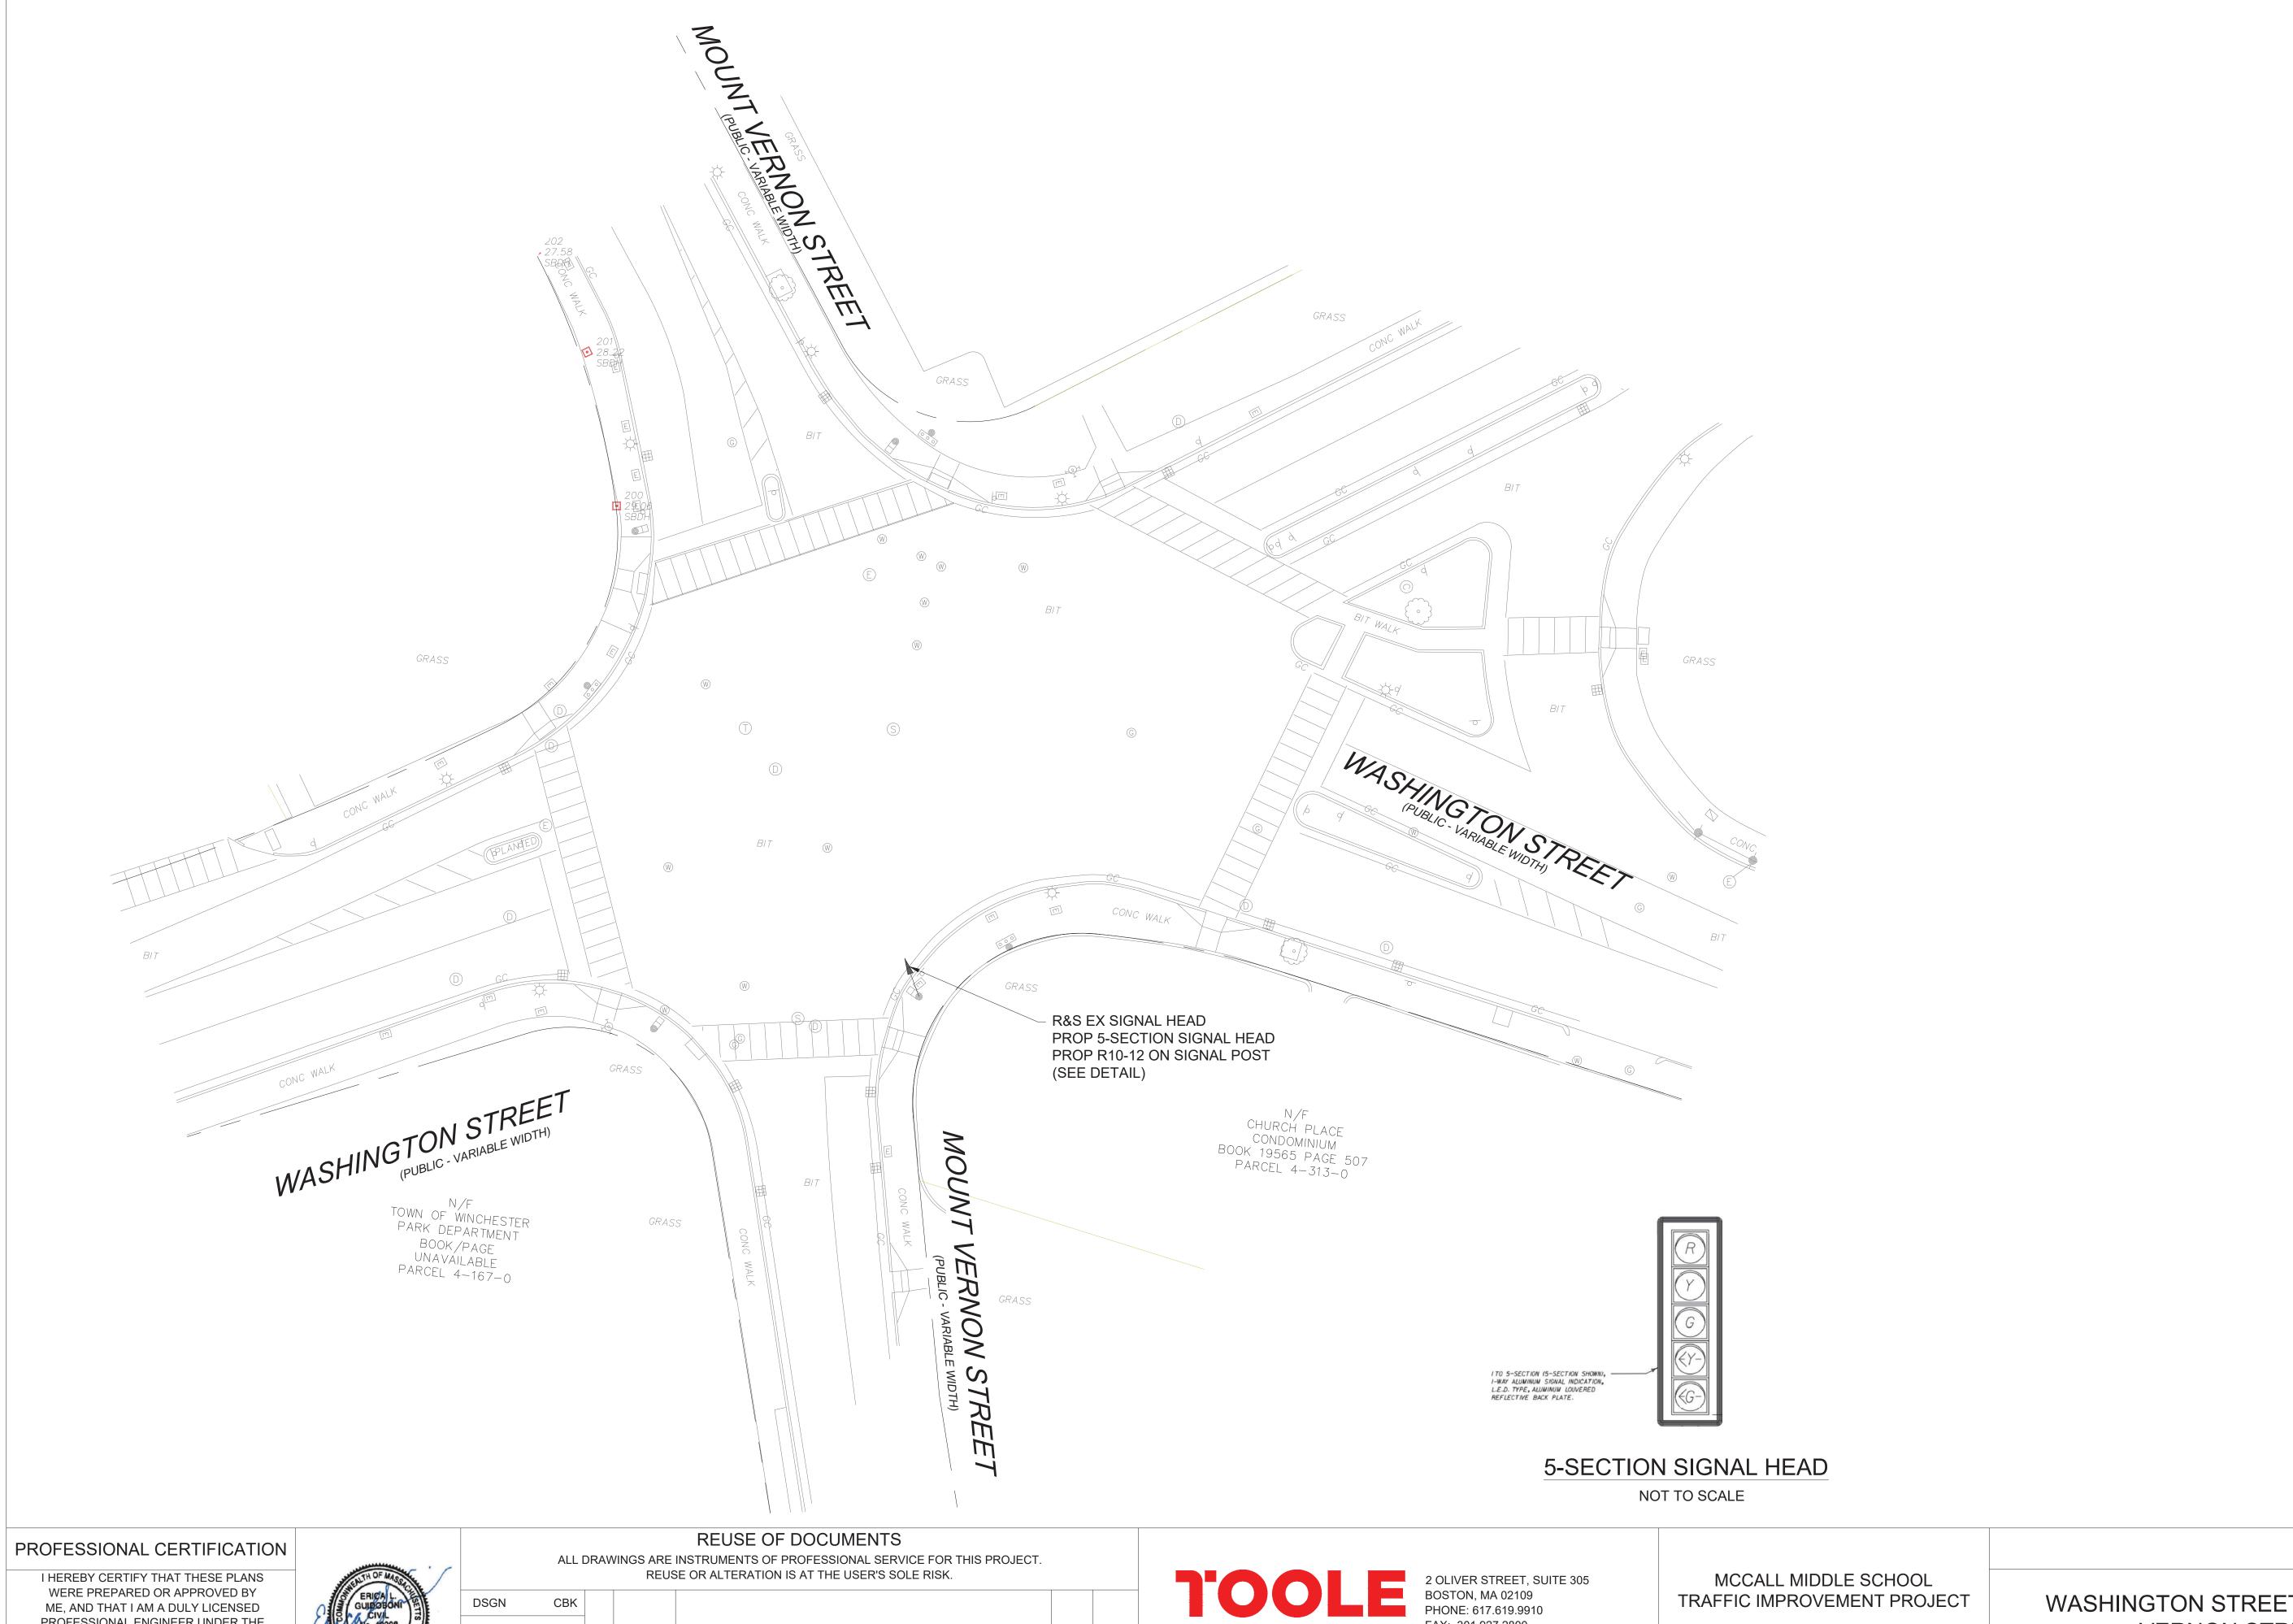FINAL DESIGN



PROFESSIONAL ENGINEER UNDER THE LAWS OF THE COMMONWEALTH OF MASSACHUSETTS, LICENSE NO. 49208, EXPIRATION DATE:6/30/2020.



RPI CHK KMF ELG NO. DATE REVISION BY APVD

2 OLIVER STREET, SUITE 305
BOSTON, MA 02109
PHONE: 617.619.9910
FAX: 301.927.2800
www.tooledesign.com

WASHINGTON STREET AT MOUNT **VERNON STREET** SIGNAL PLAN

60139 DATE 3/18/2020 DRAWING NO. SP.01 SHEET NO. 23 OF 39

PROJECT NO.

FINAL DESIGN

					TR	AFFIC SIGN SUN	MARY					
IDENTIFICATION	SIZE OF	SIGN (in)		TEXT	DIMEN	SIONS (in)	NUMBER		COLOR		UNIT AREA	TOTAL AREA
NUMBER	WIDTH	HEIGHT	LEGEND	LETTER HEIGHT	VERTI		OF SIGNS REQUIRED	BACK- GROUND	LEGEND	BORDER	(SF)	(SF)
MA-R2-10a	48	36	WORK ZONE SPEEDING FINES DOUBLED	MASSDO	OT STAI	NDARD SIGN	4 0	FL. RANGEWHI ⁻	BLACK E BLACK	BLACK BLACK	12.00	48.00
MA-R2-10e	36	48	END ROAD WORK DOUBLE FINES END		¥	,	4 0	FL. RANGEWHI ⁻	BLACK E BLACK	BLACK BLACK	12.00	48.00
R9-9	30	18	SIDEWALK CLOSED		2009 ML DIMENS	JTCD FOR SIONS	2	WHITE	BLACK	BLACK	3.75	7.50
R9-11aL	24	12	SIDEWALK CLOSED CROSS HERE				1	WHITE	BLACK	BLACK	2.00	2.00
R9-11aR	24	12	SIDEWALK CLOSED CROSS HERE				1	WHITE	BLACK	BLACK	2.00	2.00
W1-4L	36	36					2	FL. ORANGE	BLACK	BLACK	9.00	18.00
W1-4R	36	36					2	FL. ORANGE	BLACK	BLACK	9.00	18.00
W5-1	36	36	ROAD				2	FL. ORANGE	BLACK	BLACK	9.00	18.00
W11-2	30	30					4	FYG	BLACK	BLACK	6.25	25.00
W16-7pL	24	12					4	FYG	BLACK	BLACK	2.00	8.00
W20-1	36	36	ROAD WORK				4	FL. ORANGE	BLACK	BLACK	9.00	36.00
W20-4	36	36	ONE LANE ROAD AHEAD				4	FL. ORANGE	BLACK	BLACK	9.00	36.00
W20-7a	36	36					4	FL. ORANGE	BLACK	BLACK	9.00	36.00
W21-5a	36	36	RIGHT SHOULDER CLOSED			,	4	FL. ORANGE	BLACK	BLACK	9.00	36.00

					TRAFFI	C SIGN SUM	IMARY					
IDENTIFICATION	SIZE OF	SIGN (in)		TEXT	TEXT DIMENSIONS (in)		NUMBER OF SIGNS		COLOR		UNIT AREA	TOTAL AREA
NUMBER	WIDTH	HEIGHT	LEGEND	LETTER HEIGHT	VERTICAL SPACING	ARROW RTE. MKR	REQUIRED	BACK- GROUND	LEGEND	BORDER	(SF)	(SF)
MA-W20-7b	36	36	POLICE OFFICER AHEAD	MASSD	OT STANDAF	RD SIGN	4	FL. ORANGE	BLACK	BLACK	9.00	36.00

NOTES:

- ALL TEMPORARY TRAFFIC CONTROL WORK SHALL CONFORM TO THE LATEST EDITION OF THE "MANUAL ON UNIFORM TRAFFIC CONTROL DEVICES" (MUTCD) AND ALL REVISIONS, UNLESS SUPERCEDED WITH THE MUTCD.
- 2. ALL SIGN LEGENDS, BORDERS, AND MOUNTING SHALL BE IN ACCORDANCE WITH THE MUTCD.
- 3. TEMPORARY CONSTRUCTION SIGNING, AND ALL OTHER TRAFFIC CONTROL DEVICES SHALL BE IN PLACE PRIOR TO THE START OF ANY WORK.
- 4. TEMPORARY CONSTRUCTION SIGNING, BARRICADES, AND ALL OTHER NECESSARY WORK ZONE TRAFFIC CONTROL DEVICES SHALL BE REMOVED FROM THE HIGHWAY OR COVERED WHEN THEY ARE NOT REQUIRED FOR CONTROL OR TRAFFIC.
- 5. SIGNS AND SIGN SUPPORTS LOCATED ON OR NEAR THE TRAVELED WAY, CHANNELIZING DEVICES, BARRIERS, AND CRASH ATTENUATORS MUST PASS THE CRITERIA SE FORTH IN NCHRP REPORT 350, "RECOMMENDED PROCEDURES FOR THE SAFETY PERFORMANCE EVALUATION OF HIGHWAY FEATURES" AND/OR "MANUAL FOR ASSESSING SAFETY HARDWARE" (MASH).
- 6. CONTRACTORS SHALL NOTIFY EACH ABUTTER AT LEAST 24 HOURS IN ADVANCE OF THE START OF ANY WORK THAT WILL REQUIRE THE TEMPORARY CLOSURE OF ACCESS, SUCH AS CONDUIT INSTALLATION, EXISTING PAVEMENT EXCAVATION, TEMPORARY DRIVEWAY PAVEMENT PLACEMENT, AND SIMILAR OPERATIONS.
- 7. THE FIRST FIVE PLASTIC DRUMS OF A TAPER SHALL BE MOUNTED WITH TYPE A LIGHTS.
- 8. THE ADVISORY SPEED LIMIT, IF REQUIRED, SHALL BE DETERMINED BY THE ENGINEER.
- 9. DISTANCES ARE A GUIDE AND MAY BE ADJUSTED IN THE FIELD BY THE ENGINEER.
- 10. MAXIMUM SPACING OF TRAFFIC DEVICES IN A TAPER (DRUMS OR CONES) IS EQUAL IN FEET TO THE SPEED LIMIT IN MPH.
- 11. MINIMUM LANE WIDTH IS TO BE 11 FEET (3.3M) UNLESS OTHERWISE SHOWN. MINIMUM LANE WIDTH TO BE MEASURED FROM THE EDGE OF DRUMS OR MEDIAN BARRIER.
- 12. ALL SIGNS SHALL BE MOUNTED ON THEIR OWN STANDARD SIGN SUPPORTS.

NOTES:

- ALL CONSTRUCTION SIGNING, DRUMS, BARRICADES AND OTHER DEVICES SHALL CONFORM WITH THE 2009 MANUAL ON UNIFORM TRAFFIC CONTROL DEVICES (M.U.T.C.D.) AS AMENDED.
- 2. ALL DRUMS SHALL BE APPROXIMATELY PLACED AND MOVED AS NECESSARY TO MAINTAIN ADEQUATE ABUTTER ACCESS AT ALL TIMES. WORK MAY REQUIRE ADDITIONAL SIGNS, DRUMS AND OTHER TRAFFIC CONTROL DEVICES, GRADING AND TEMPORARY PAVEMENT FOR PASSAGE OF PEDESTRIAN, VEHICULAR AND EMERGENCY TRAFFIC THROUGH THE WORK AREAS, BOTH DURING AND AFTER WORKING HOURS, TO MAINTAIN SUCH ACCESS. THE FIRST TEN DRUMS SHALL BE MOUNTED WITH SEQUENTIAL FLASHING LIGHTS. MAX SPACING OF DRUMS/CONES IS EQUAL IN FEET TO THE SPEED LIMIT IN MPH.
- 3. THE CONTRACTOR SHALL NOTIFY EACH ABUTTER AT LEAST 24 HOURS IN ADVANCE OF THE START OF ANY WORK THAT WILL REQUIRE THE TEMPORARY CLOSURE OF ACCESS, SUCH AS CONDUIT INSTALLATION, EXISTING PAVEMENT EXCAVATION, TEMPORARY DRIVEWAY PAVEMENT PLACEMENT AND SIMILAR OPERATIONS.
- 4. A MINIMUM OF ONE LANE OF TRAFFIC IN EACH DIRECTION ON TWO WAY STREETS SHALL BE MAINTAINED AT ALL TIMES. EXCEPT AT PEAK HOURS, TRAFFIC DURING WORKING HOURS MAY BE REDUCED TO ONE LANE UNDER POLICE CONTROL FOR SHORT TIME PERIODS WHEN REQUIRED FOR THE WORK, AS APPROVED BY MASSDOT.
- 5. GRADE SEPARATIONS IN EXCESS OF 2" DURING NON-WORKING HOURS SHALL REQUIRE DELINEATION BY USE OF DRUMS.
- 6. EXCAVATION EDGES IN EXCESS OF 4" DEEP SHALL BE PROTECTED DURING NON-WORKING HOURS BY BACKFILLING WITH A WEDGE OF GRAVEL OR SOIL TO COMPACTED 4:1 SLOPE.
- 7. 11' MINIMUM LANE WIDTHS SHALL BE MAINTAINED AT ALL TIMES.
- 8. NON-ESSENTIAL TRAFFIC CONTROL DEVICES SHALL BE COVERED OR REMOVED DURING NON-WORKING HOURS.
- 9. FLAGGERS MAY NOT BE USED FOR TRAFFIC CONTROL AT INTERSECTIONS.
- 10. SEE SHEET 21 FOR PEDESTRIAN TRAFFIC CONTROL DETAILS.
- 11. CONTRACTOR SHALL MAINTAIN ADA-COMPLIANT PEDESTRIAN ACCESS AT ALL TIMES, SPECIFICALLY INCLUDING PEDESTRIAN GUIDANCE SYSTEMS AT WORK ZONES. ACCESS SHALL BE MAINTAINED ALONG ALL SIDEWALKS AND CROSSWALKS, TO ALL ABUTTERS, AND TO ALL MBTA BUS STOPS OR TRAIN STATIONS. ANY PEDESTRIAN DETOURS SHALL INCLUDE A FULLY ADA-COMPLIANT PEDESTRIAN DETOUR ROUTE WITH PROPER BARRICADES, RAILINGS, RAMPS, AND SIGNAGE.

FINAL DESIGN

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MCCALL MIDDLE SCHOOL
TRAFFIC IMPROVEMENT PROJECT

TEMPORARY TRAFFIC CONTROL PLANS

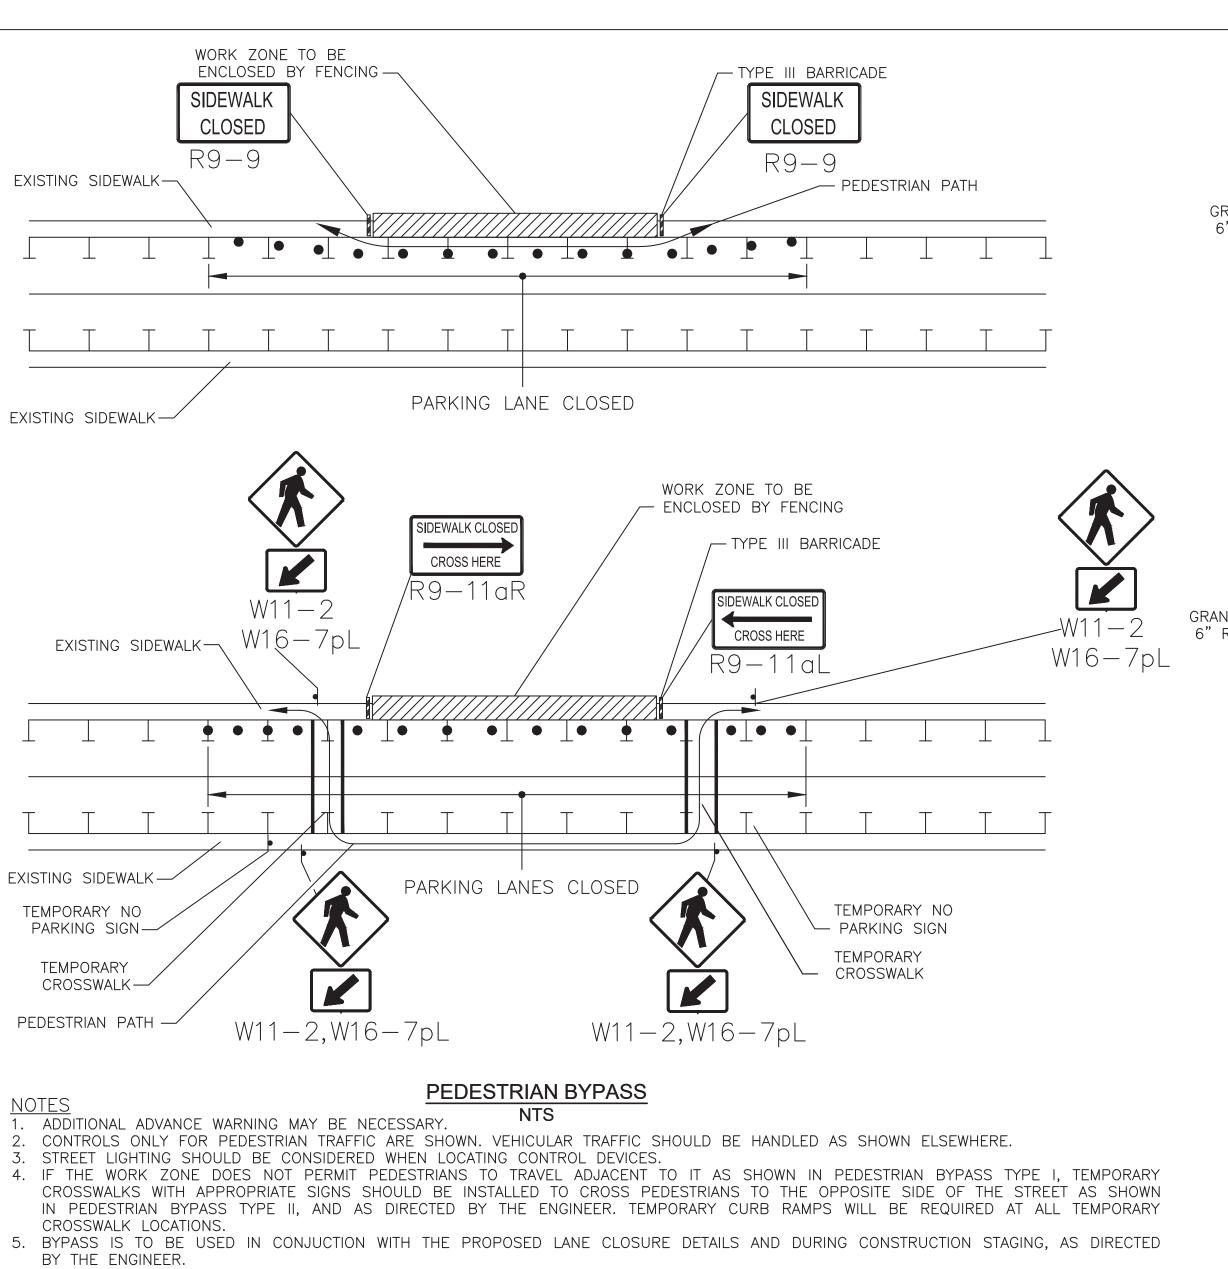
PROJECT NO.
60139

DATE
3/18/2020


DRAWING NO.
TTCP.01

24 OF 39

SHEET NO.



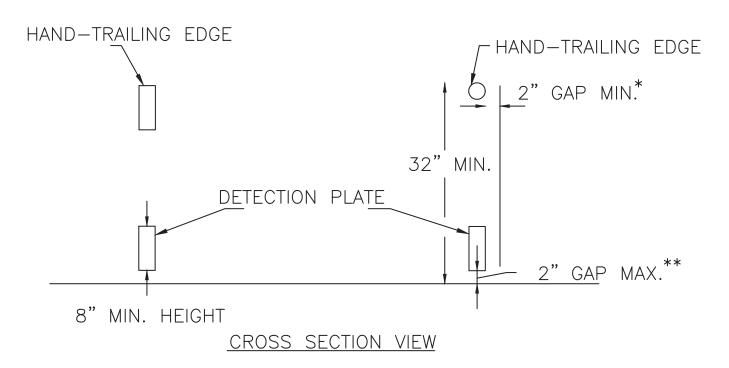
- 6. THE TEMPORARY SIDEWALK SHOULD BE A MINIMUM OF 4 FEET WIDE. IF THIS WALKWAY EXCEEDS 200 FEET THEN A 5 FOOT X 5 FOOT PASSING ZONE. (FOR SHORT TERM SETUPS < 10 HOURS, THIS CONDITION MAY BE WAIVED. A NOTE WOULD NEED TO BE INCLUDED IN THE TTCP THAT STATES HOW THE CONTRACTOR SHOULD ADDRESS THIS ISSUE.)




PEDESTRIAN CHANNELIZING DEVICE

NOTES:

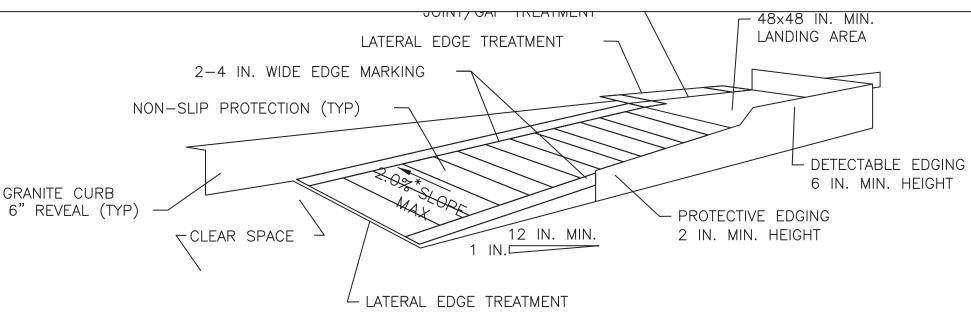- * THERE SHALL BE A 2 INCH GAP BETWEEN THE HAND-TRAILING EDGE AND ITS SUPPORT
- ** A MAXIMUM 2 INCH GAP BETWEEN THE BOTTOM OF THE BOTTOM RAIL AND THE SURFACE MAY BE USED TO PROVIDE DRAINAGE



TEMPORARY CURB RAMP-PARALLEL TO CURB

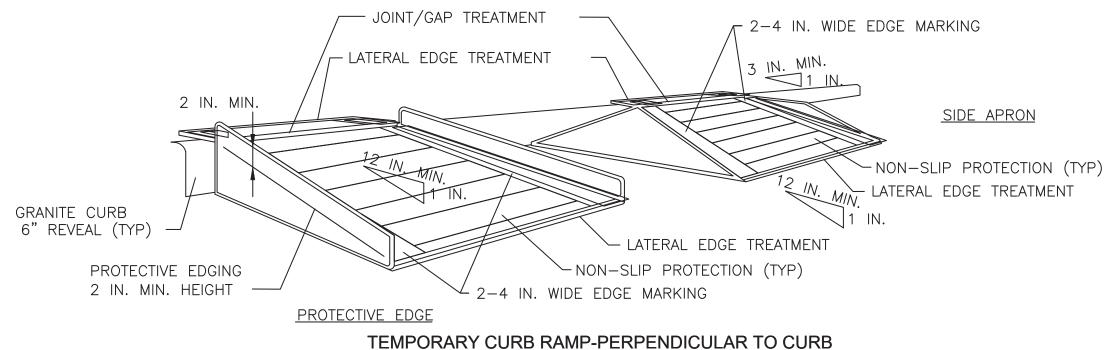

NOTES:

48" MIN

- 1. CURB RAMPS SHALL BE 60 IN. MINIMUM WIDTH WITH A FIRM, STABLE AND NON-SLIP SURFACE.
- 2. PROTECTIVE EDGING WITH A 2 IN. MINIMUM HEIGHT SHALL BE INSTALLED WHEN THE CURB RAMP OR LANDING PLATFORM HAS A VERTICAL DROP OF 6 IN. OR GREATER OR HAS A SIDE APRON SLOP STEEPER THAN 1:3 (33%). PROTECTIVE EDGING SHOULD BE CONSIDERED WHEN THE CURB RAMPS OR LANDING PLATFORMS HAVE A VERTICAL DROP OF 3 IN. OR MORE
- 3. DETECTABLE EDGING WITH 6 IN. MINIMUM HEIGHT AND CONTRASTING COLOR SHALL BE INSTALLED ON ALL CURB RAMP LANDINGS WHERE THE WALKWAY CHANGES DIRECTION
- 4. CURB RAMPS AND LANDINGS SHOULD HAVE A 1:50 (2%) MAX CROSS-SLOPE.

-DETECTABLE WARNING PANEL

48" MIN

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TEMPORARY PEDESTRIAN FACILITY

3:1 MAX SLOPE INTO GUTTER—

TEMPORARY CURB RAMP-

48" MIN LANDING AREA

WITHOUT EDGE PROTECTION OR DETECTABLE EDGE

PORTABLE WALKWAY_

DETECTABLE EDGE

LANDING

AREA

DETECTABLE EDGING-

72" MAX

CURB RAMP

- 5. CLEAR SPACE OF 48x48 IN. MINIMUM SHALL BE PROVIDED ABOVE AND BELOW THE CURB RAMP
- THE CURB RAMP WALKWAY EDGE SHALL BE MARKED WITH A CONTRASTING COLOR 2 TO 4 IN. WIDE MARKING. THE MARKING IS OPTIONAL WHERE COLOR CONTRASTING EDGING
- IS USED. 7. WATER FLOW IN THE GUTTER SYSTEM SHALL HAVE MINIMAL
- 8. LATERAL JOINTS OR GAPS BETWEEN SURFACES SHALL BE LESS THAN 0.5 IN. WIDTH.

WORK ZONE AREA (CLOSED)

AREA

-GROUND SURFACE

-GROUND SURFACE

-CURB

48" MIN LANDING AREA

ſURNING∖

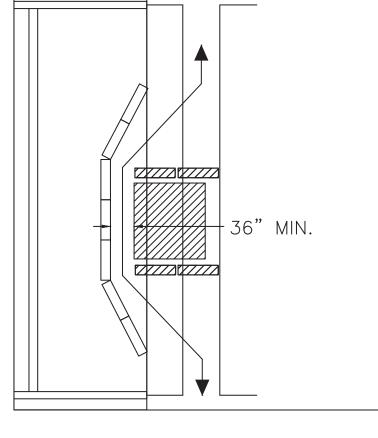
EXISTING SIDEWALK

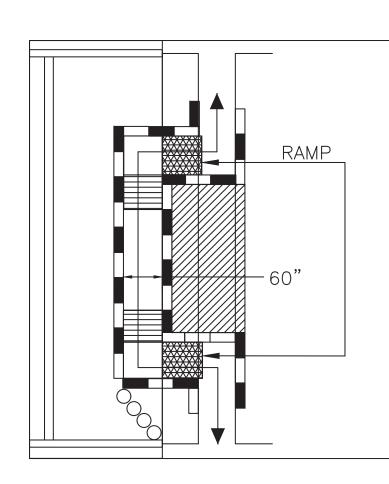
TURNING AREA

PORTABLE

WALKWAY

9. CHANGES BETWEEN SURFACE HEIGHTS SHOULD NOT EXCEED 0.5 IN. LATERAL EDGES SHOULD BE VERTICAL UP TO 0.25 IN. HIGH, AND BEVELED AT 1:2 BETWEEN 0.25 IN. AND 0.5 IN. HEIGHT.





PEDESTRIAN BYPASS

NTS

- When existing pedestrian facilities are disrupted, closed, or relocated in a TTC zone, temporary facilities shall be provided and they shall be detectable and include accessibility features consistent with the features present in the existing pedestrian facility.
- A pedestrian channelizing device that is detectable by a person with a visual disability traveling with the aid of a long cane shall be placed across the full width of the closed
- When used, temporary ramps shall comply with Americans with Disabilities Act (see Figures Ped-1 & Ped-2). • The alternate pathway should have a smooth continuous hard surface for the entire length
- of the temporary pedestrian facility. • The protective requirements of a TTC situation have priority in determining the need for
- temporary traffic barriers and their use in this situation should be based on engineering judgment.
- Audible information devices should be considered where midblock closings and changed crosswalk areas cause inadequate communication to be provided to pedestrians who have visual disabilities.

AUDIBLE DEVICES

For long term sidewalk closures (at a minimum overnight) a form of speech messaging for devices should be considered for these cases. These audible devices can be mountable or

pedestrians with visual disabilities shall be provided. Audible information devices such as detectable barriers or barricades and other passive pedestrian activation (motion activated) stand alone.


EXISTING SURFACE OR TEMPORARY PEDESTRIAN FACILITY

6" MAX—∕

TEMPORARY CURB RAMP-TYPE 2

PROFESSIONAL CERTIFICATION

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MCCALL MIDDLE SCHOOL TRAFFIC IMPROVEMENT PROJECT

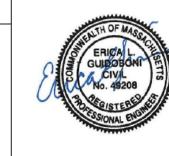-EXISTING SIDEWALK

CONTRAST

MARKING ON

NON-SMOOTH

JOINTS (TYP)

TRANSITION

TEMPORARY TRAFFIC CONTROL PLANS

PROJECT NO. 60139 DATE 3/18/2020 DRAWING NO. TTCP.02

SHEET NO. **25** OF 39

FINAL DESIGN


FORMULAS FOR DETERMINING TAPER LENGTHS

SPEED LIMIT (S)	TAPER LENGTH (L) FEET
40 MPH OR LESS	$L = \frac{WS^2}{60}$
45 MPH OR MORE	L= WS


WHERE: L = TAPER LENGTH IN FEET (METERS)

W = WIDTH OF OFFSET IN FEET (METERS)

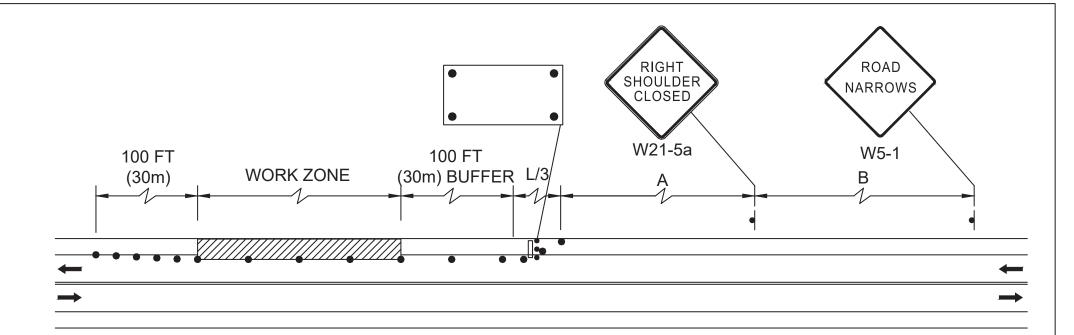S = POSTED SPEED LIMIT, OR OFF-PEAK 85TH-PERCENTILE SPEED PRIOR TO WORK STARTING, OR THE ANTICAPATED OPERATING SPEED IN MPH




TWO LANE ROAD SHOULDER CLOSED NTS

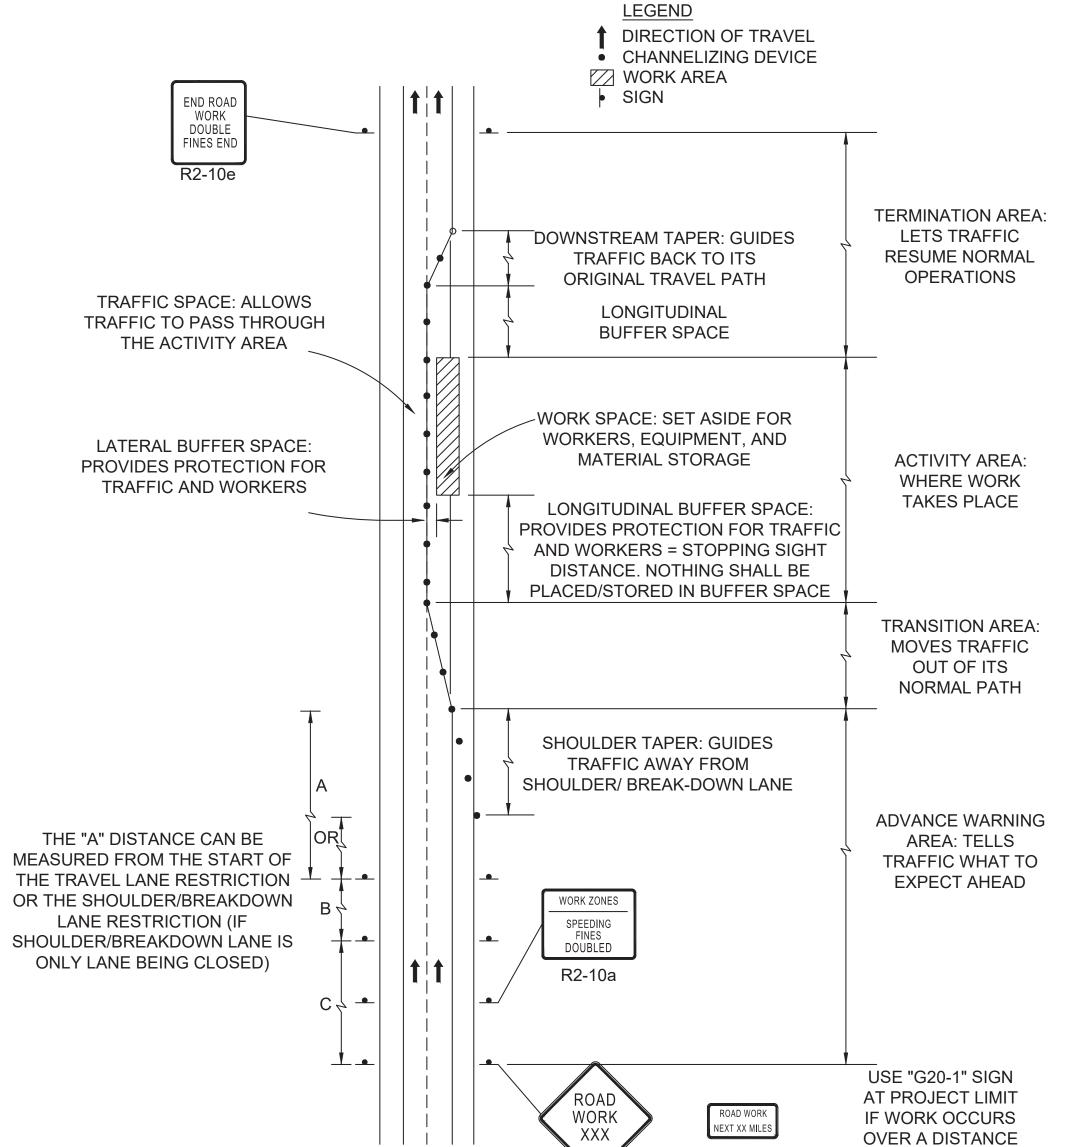


W20-SERIES

COMPONENT PARTS OF A TEMPORARY TRAFFIC CONTROL (TTC) ZONE

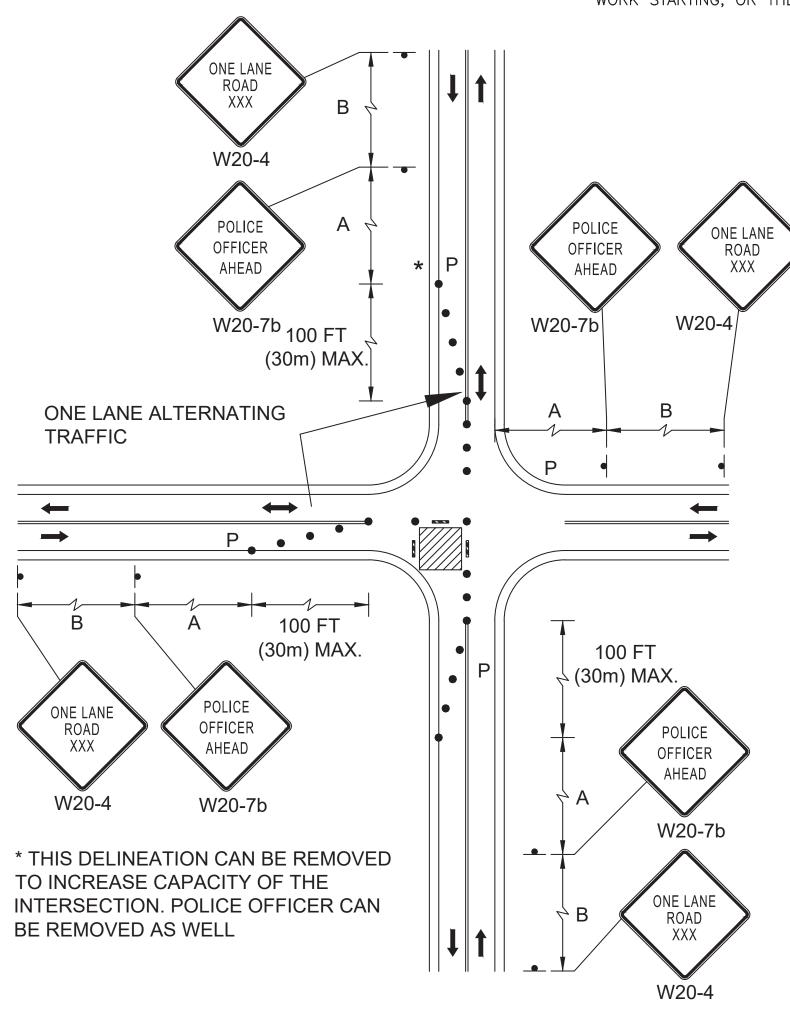G20-1



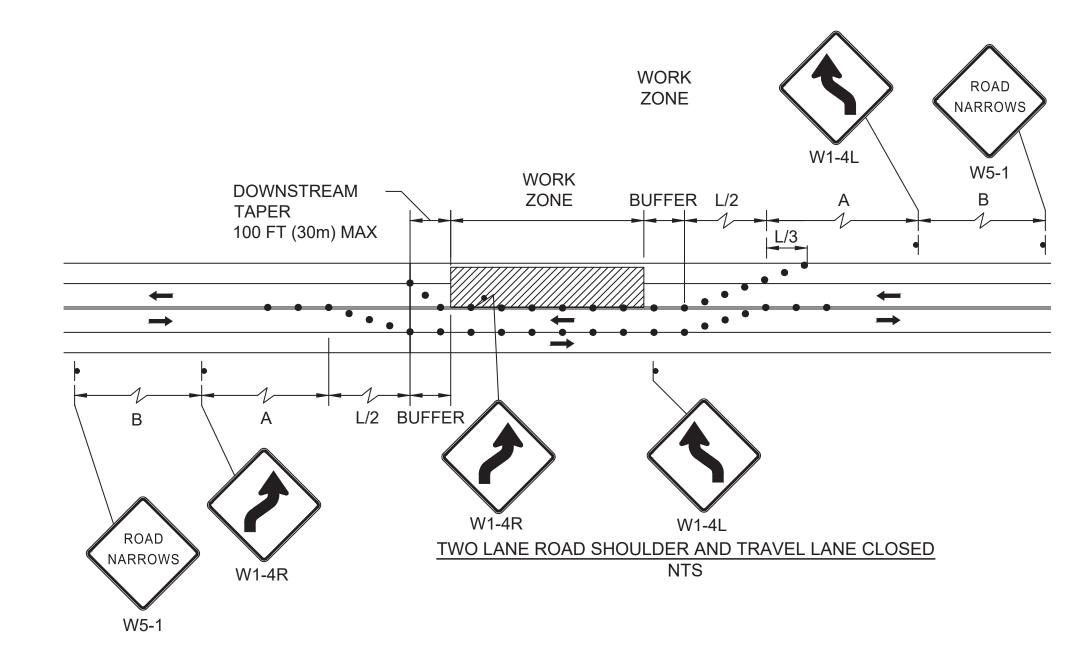SINGLE LANE APPROACH ONE QUADRANT CLOSURE



OFFICER **BUFFER** 100-150FT 100FT ZONE (30-45m) (30m) MAX.

ONE LANE ROAD XXX XX M.P.H. W20-4 W13-1p

100FT (30m) MAX.

• • •

W20-7

TWO LANE ROAD ONE LANE ALTERNATING TRAFFIC

TAPER LENGTH CRITERIA FOR TEMPORARY TRAFFIC CONTROL ZONES

TYPE OF TAPER	TAPER LENGTH (L)*
MERGING TAPER	AT LEAST L
SHIFTING TAPER	AT LEAST 0.5L
SHOULDER TAPER	AT LEAST 0.33L
ONE-LANE, TWO-WAY TRAFFIC TAPER	50 FT MIN. 100 FT MAX.
DOWNSTREAM TAPER	50 FT MIN. 100 FT MAX. PER LANE

PROFESSIONAL CERTIFICATION

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ÐR	RPI						
CHK	KMF						
APVD	ELG	NO.	DATE	REVISION	BY	APVD	

OF MORE THAN 2

MILES (3.2 KM)



MCCALL MIDDLE SCHOOL TRAFFIC IMPROVEMENT PROJECT

OFFICER

AHEAD

W20-7b

ONE LANE ROAD XXX

XX M.P.H. W20-4


W13-1p

TEMPORARY TRAFFIC CONTROL PLANS	DF
	SH

	PROJECT NO.
	60139
	DATE
	3/18/2020
ANS	DRAWING NO.
LANS	TTCP.03
	SHEET NO.
	26 OF 39

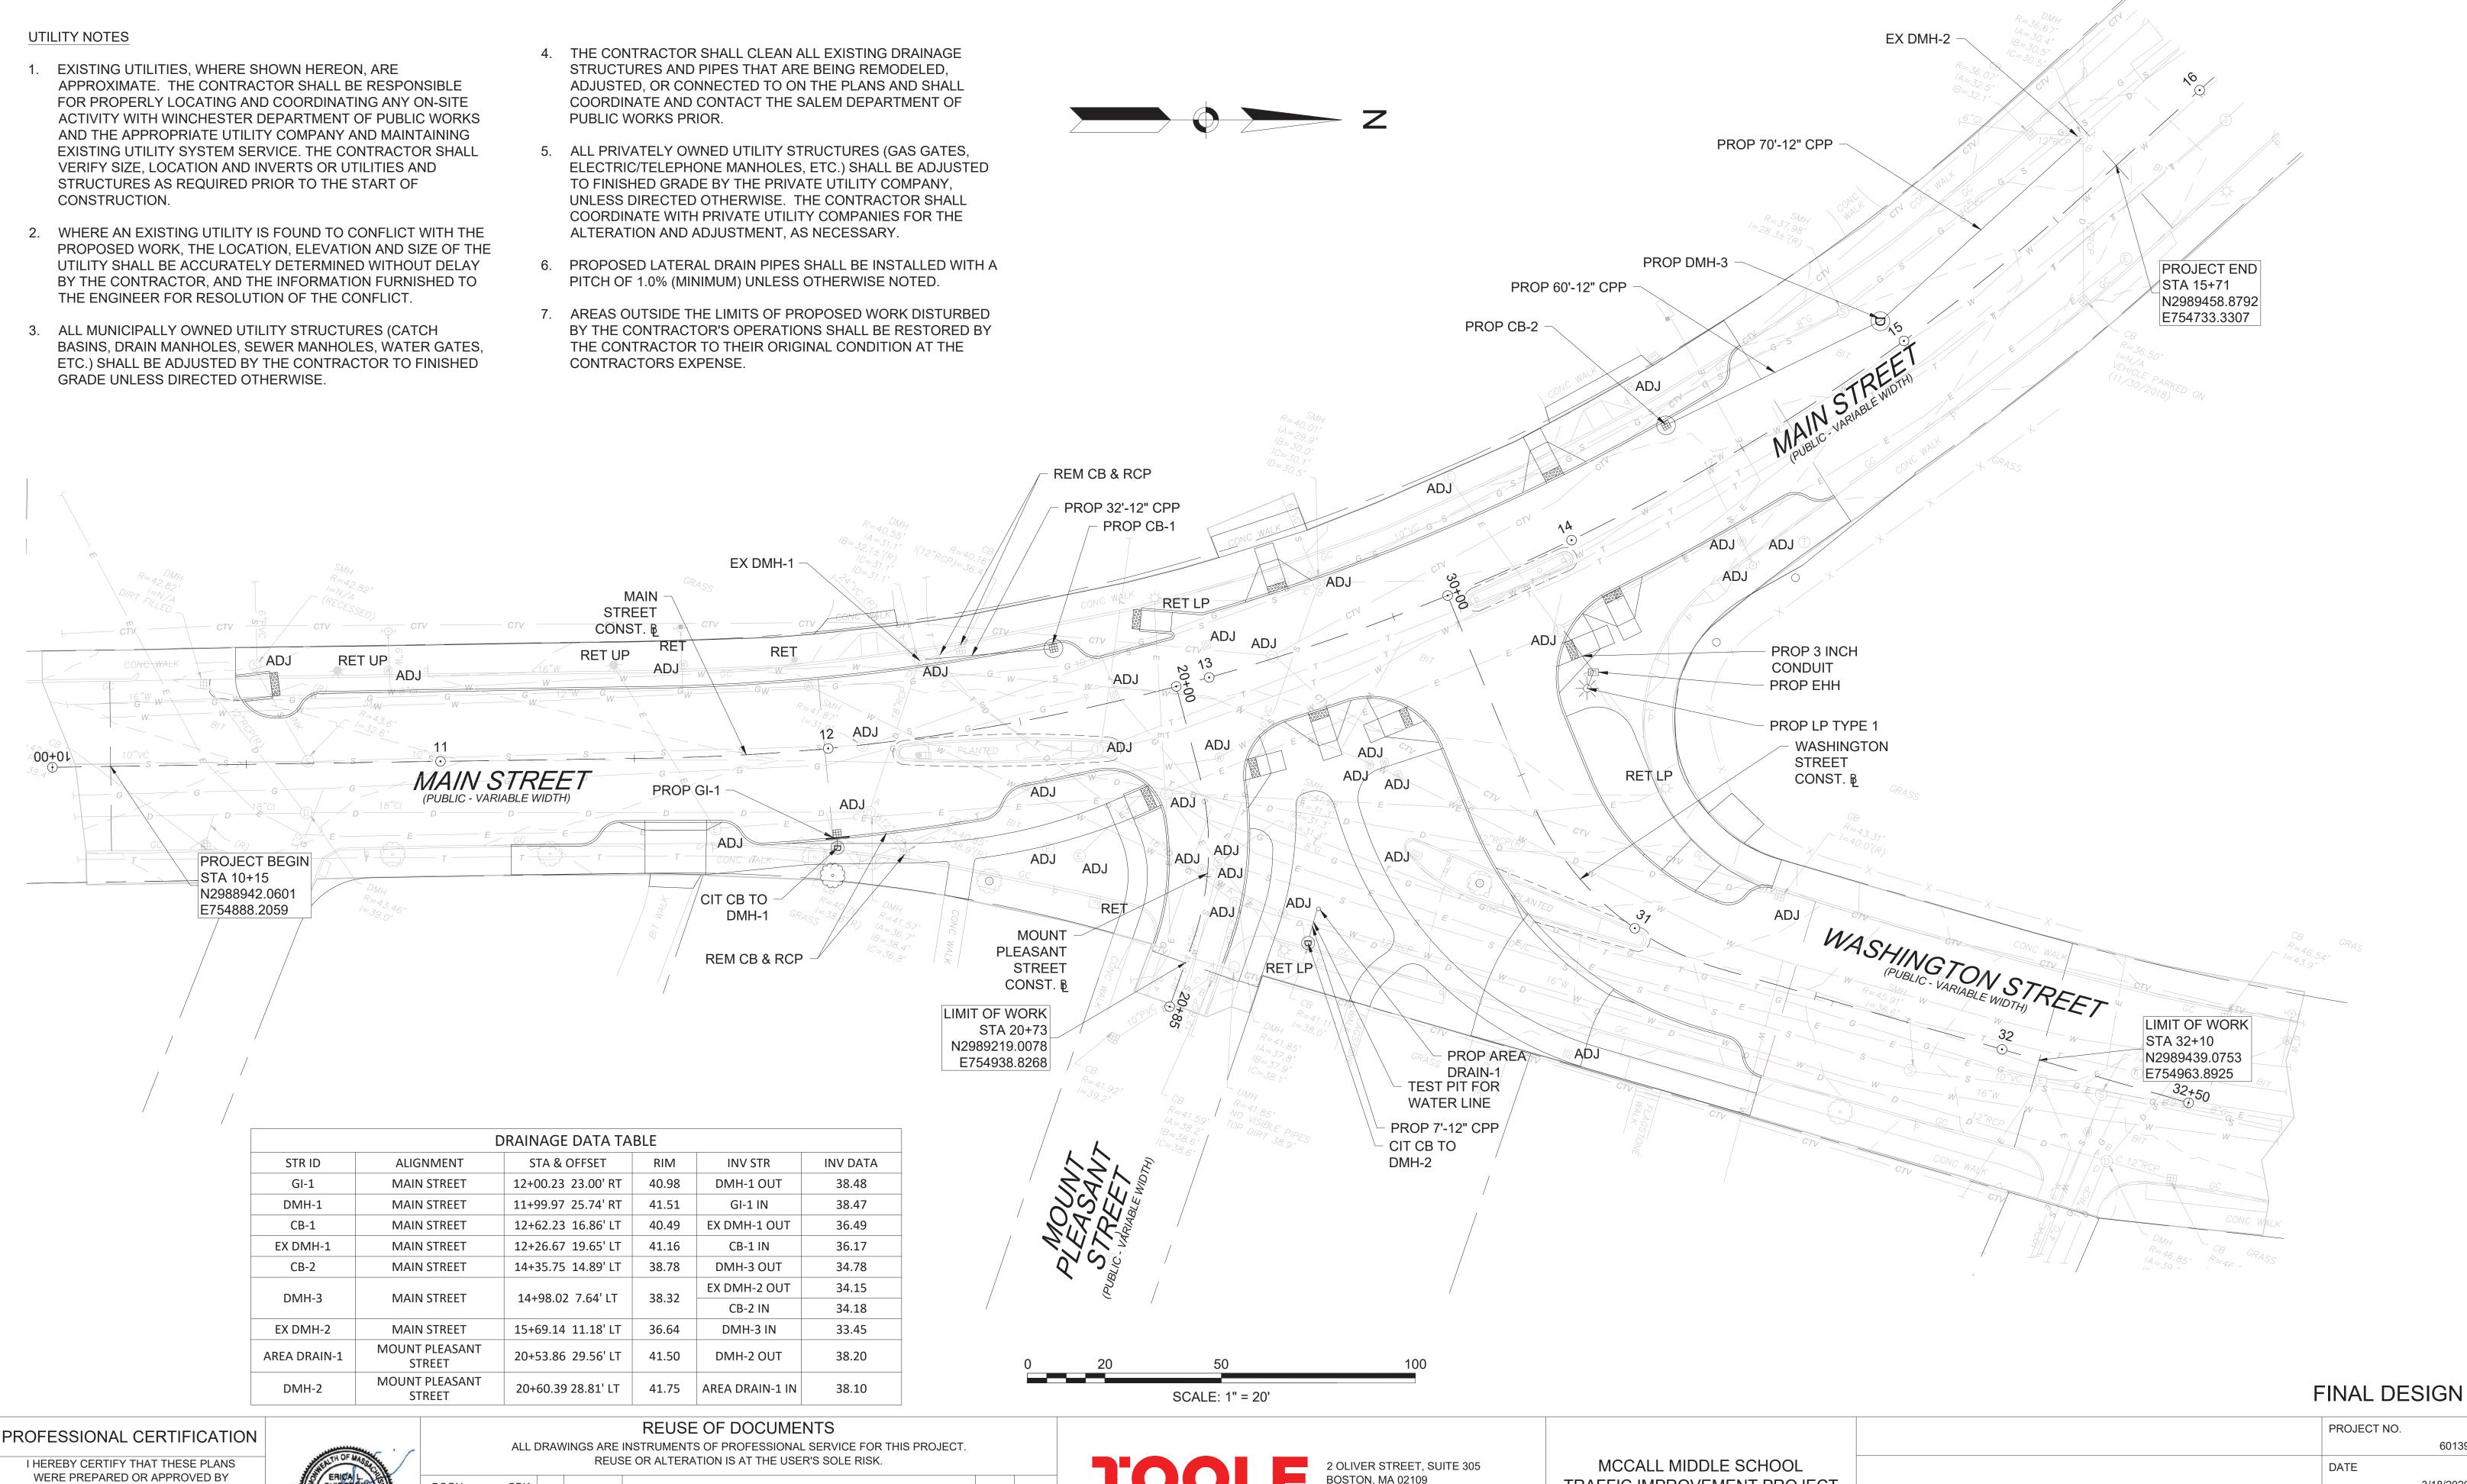FINAL DESIGN

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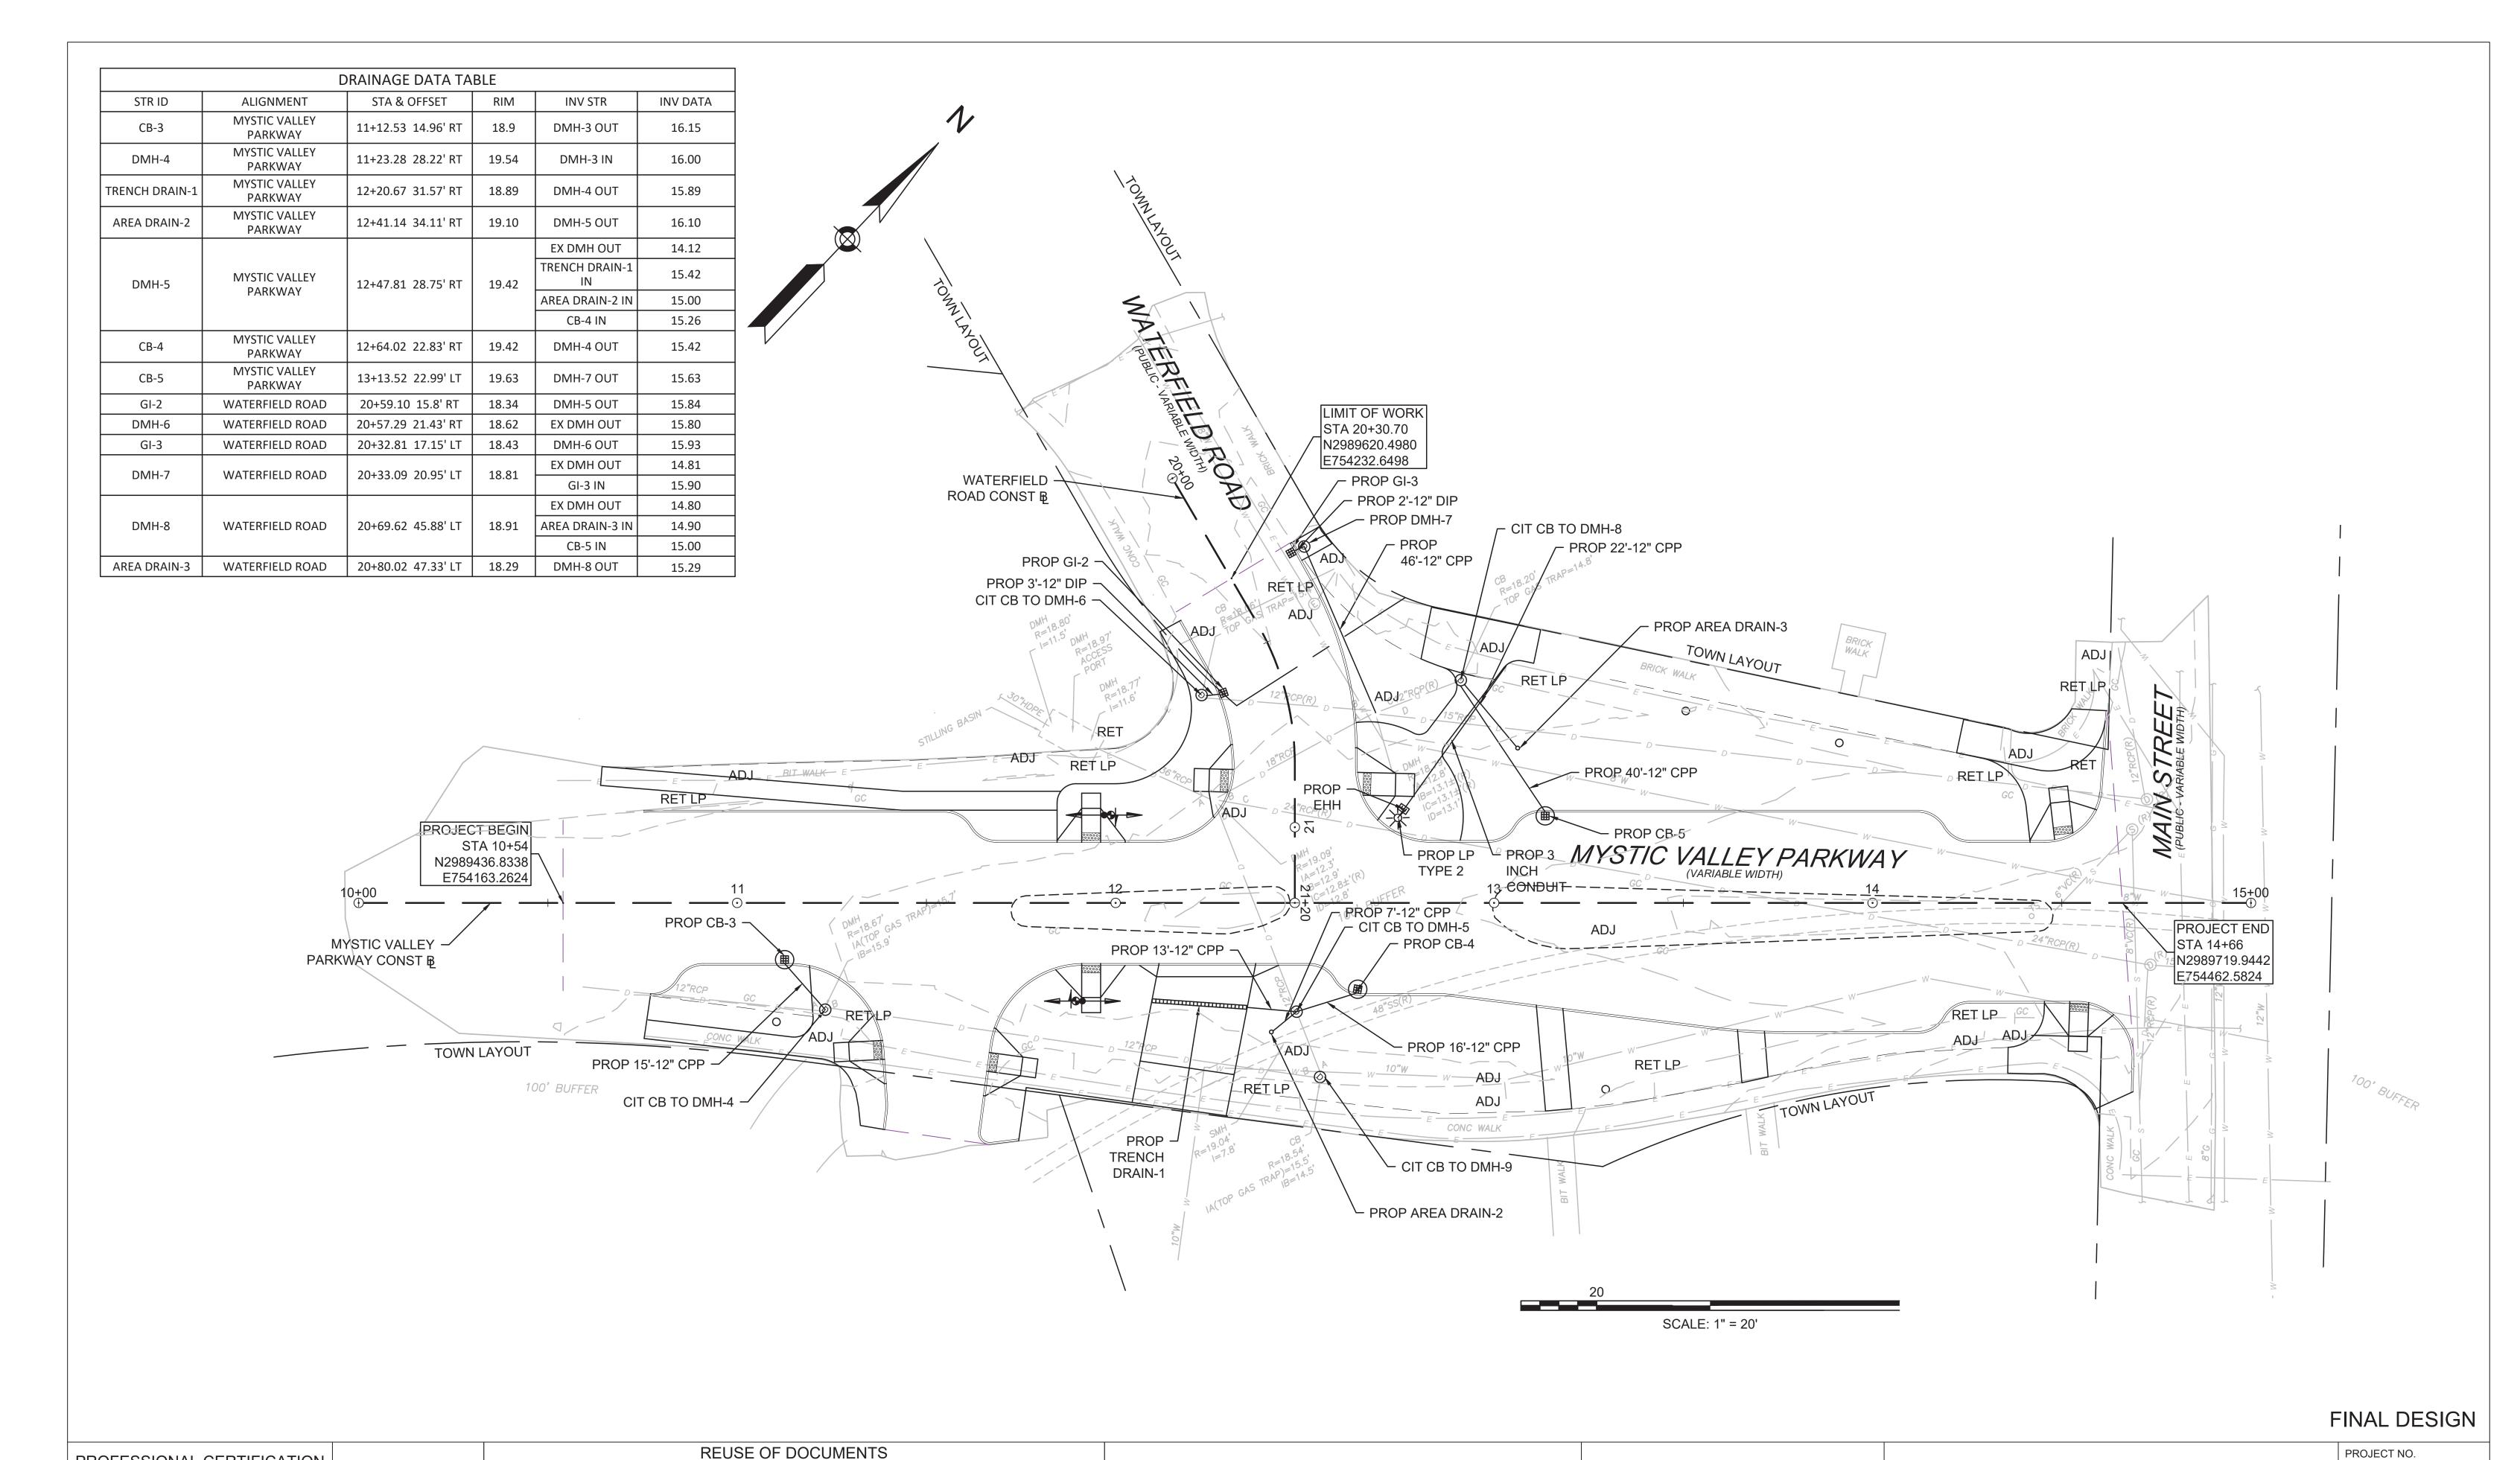
			REUS	SE OR ALTERATION IS AT THE USER'S SOLE RISK.			
DSGN	CBK						
DR	RPI						
CHK	KMF						
APVD	ELG	NO.	DATE	REVISION	BY	APVD	
	DR CHK	DR RPI CHK KMF	DR RPI CHK KMF	DSGN CBK DR RPI CHK KMF	DR RPI CHK KMF	DSGN CBK DR RPI CHK KMF	DSGN CBK DR RPI CHK KMF



TRAFFIC IMPROVEMENT PROJECT

MAIN STREET AT WASHINGTON STREE DRAINAGE AND UTILITY PLAN

		60139
	DATE	
		3/18/2020
ΞΤ	DRAWING NO.	
		DU.01
	SHEET NO.	
		27 OF 39



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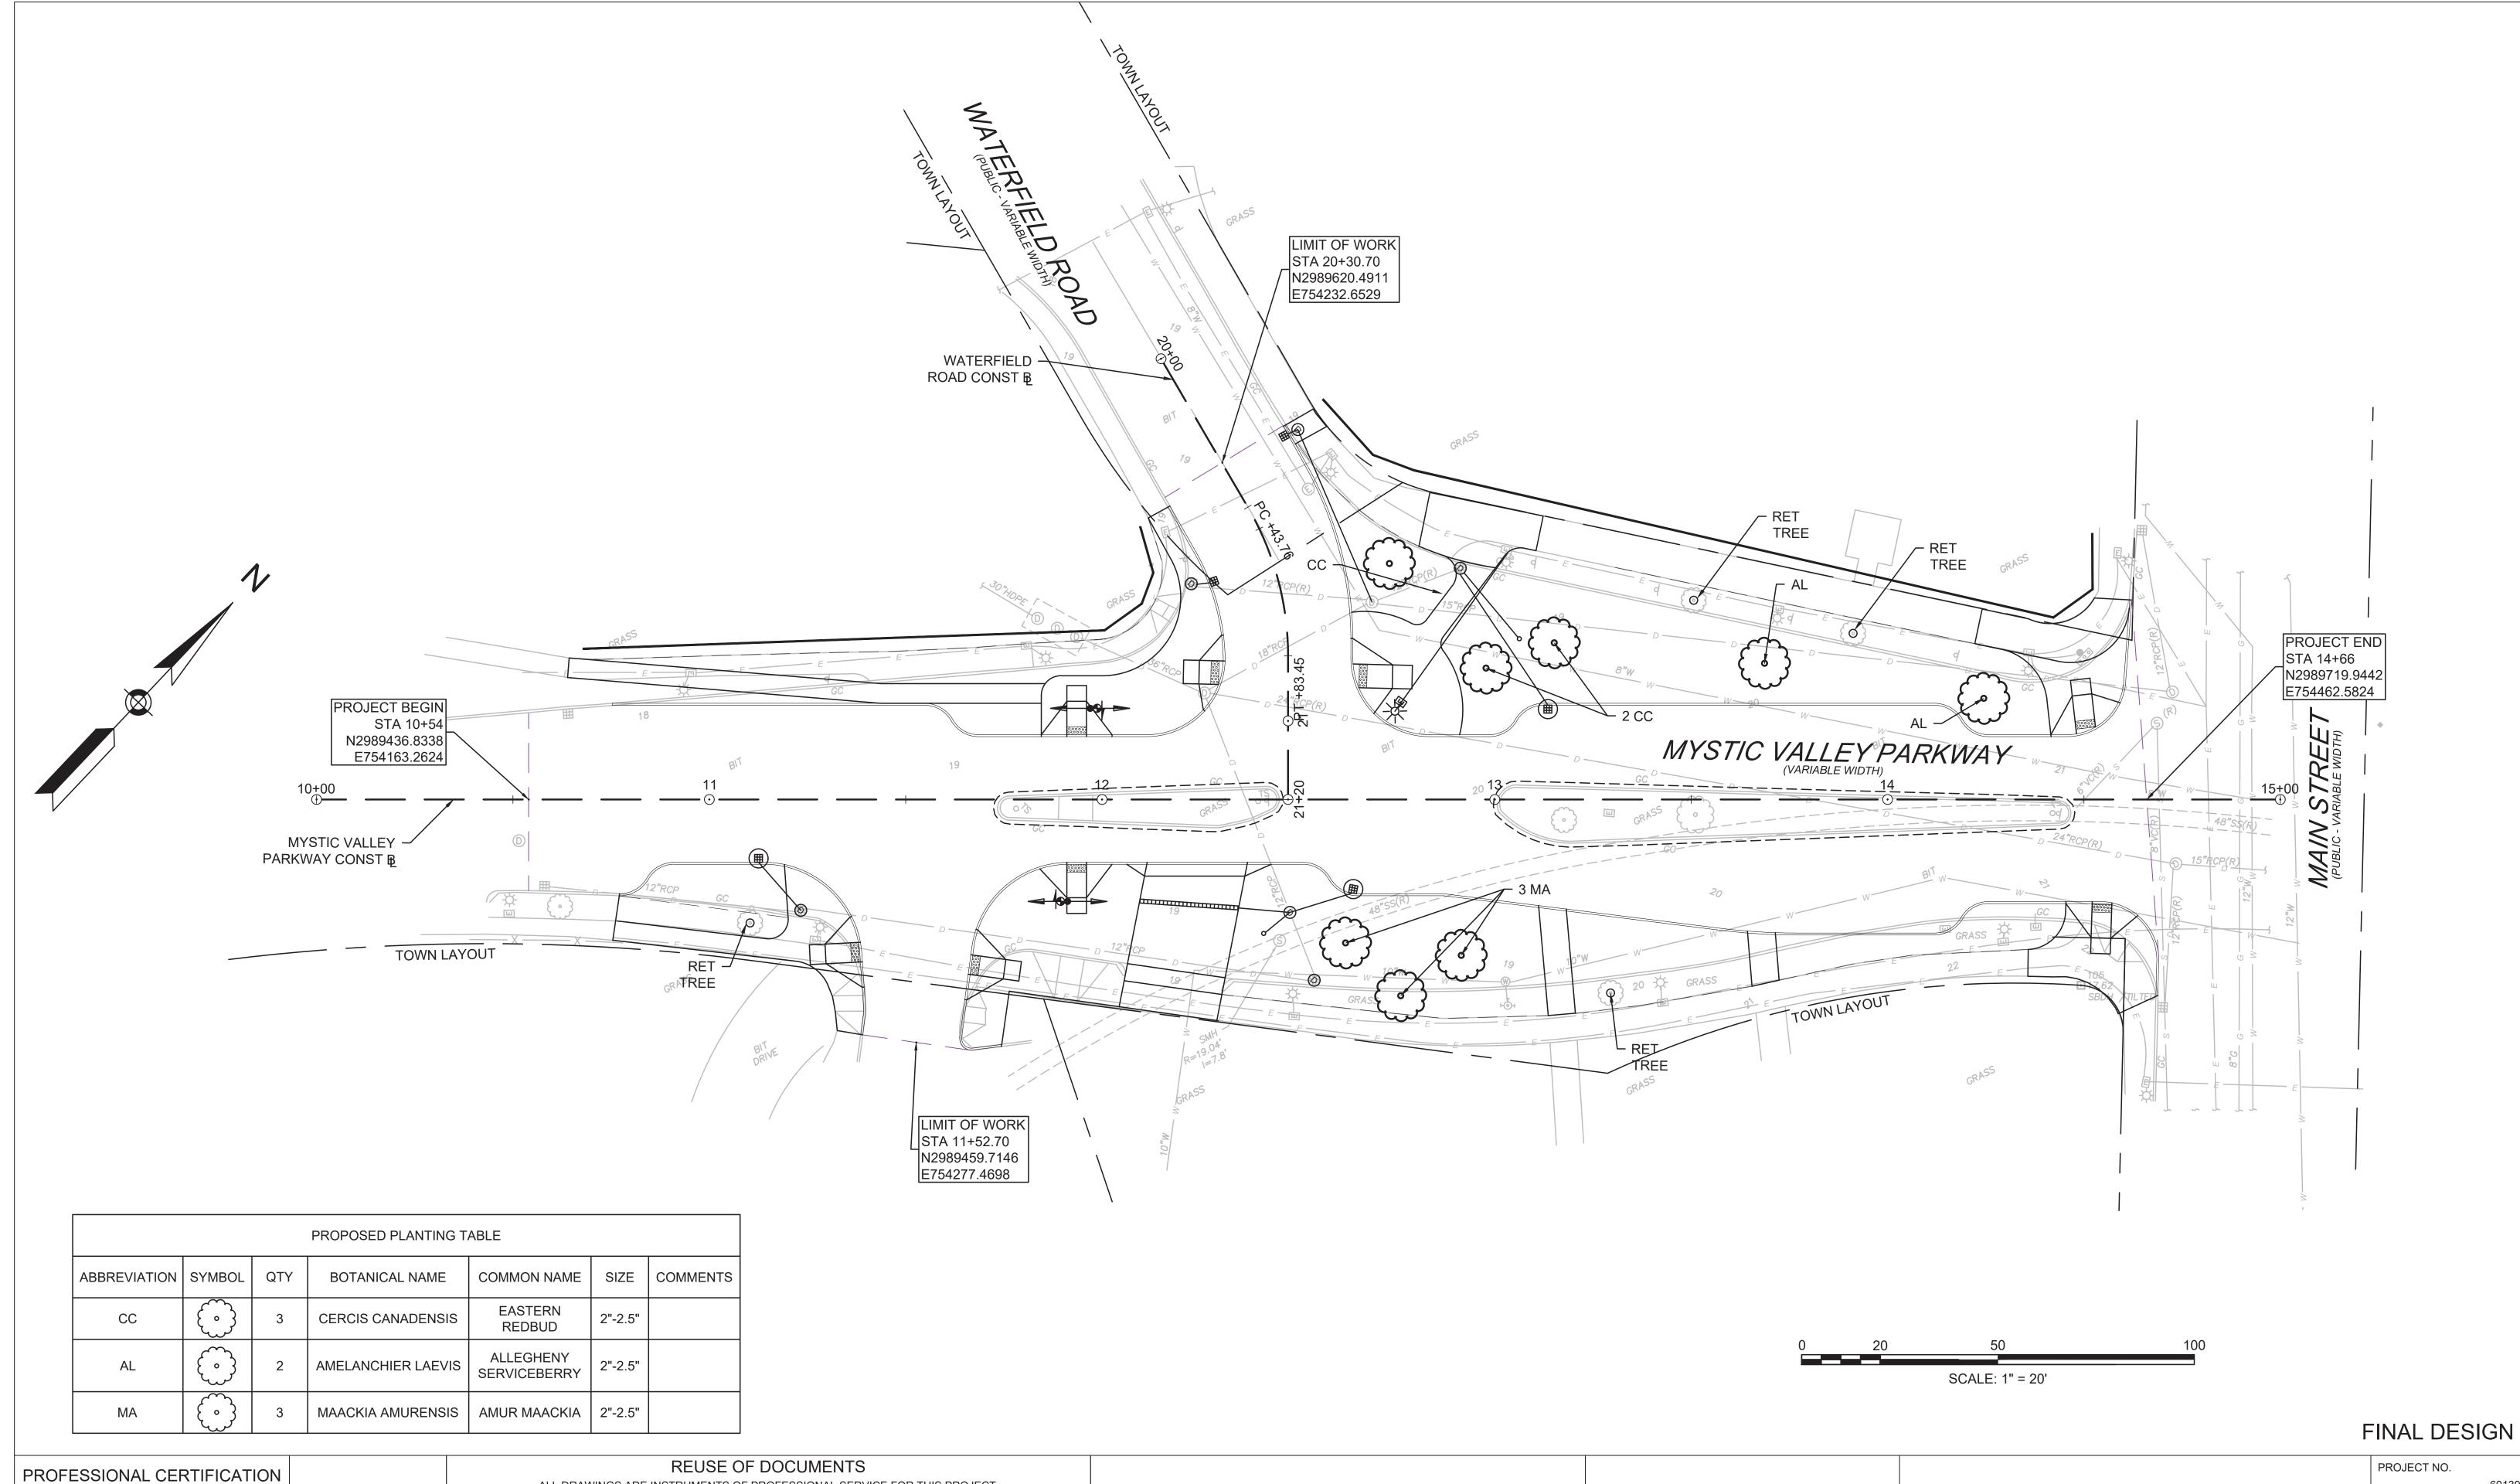
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2 OLIVER STREET, SUITE 305 BOSTON, MA 02109 PHONE: 617.619.9910 FAX: 301.927.2800 www.tooledesign.com

MCCALL MIDDLE SCHOOL TRAFFIC IMPROVEMENT PROJECT

MYSTIC VALLEY PARKWAY DRAINAGE AND UTILITY PLAN

	60139
DATE	
	3/18/2020
DRAWING NO.	
	DU.02
SHEET NO.	
	28 OF 39



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CHK

KMF

ELG NO. DATE

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BY APVD

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BOSTON, MA 02109
PHONE: 617.619.9910
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www.tooledesign.com

MCCALL MIDDLE SCHOOL
TRAFFIC IMPROVEMENT PROJECT

MYSTIC VALLEY PARKWAY PLANTING PLAN DATE

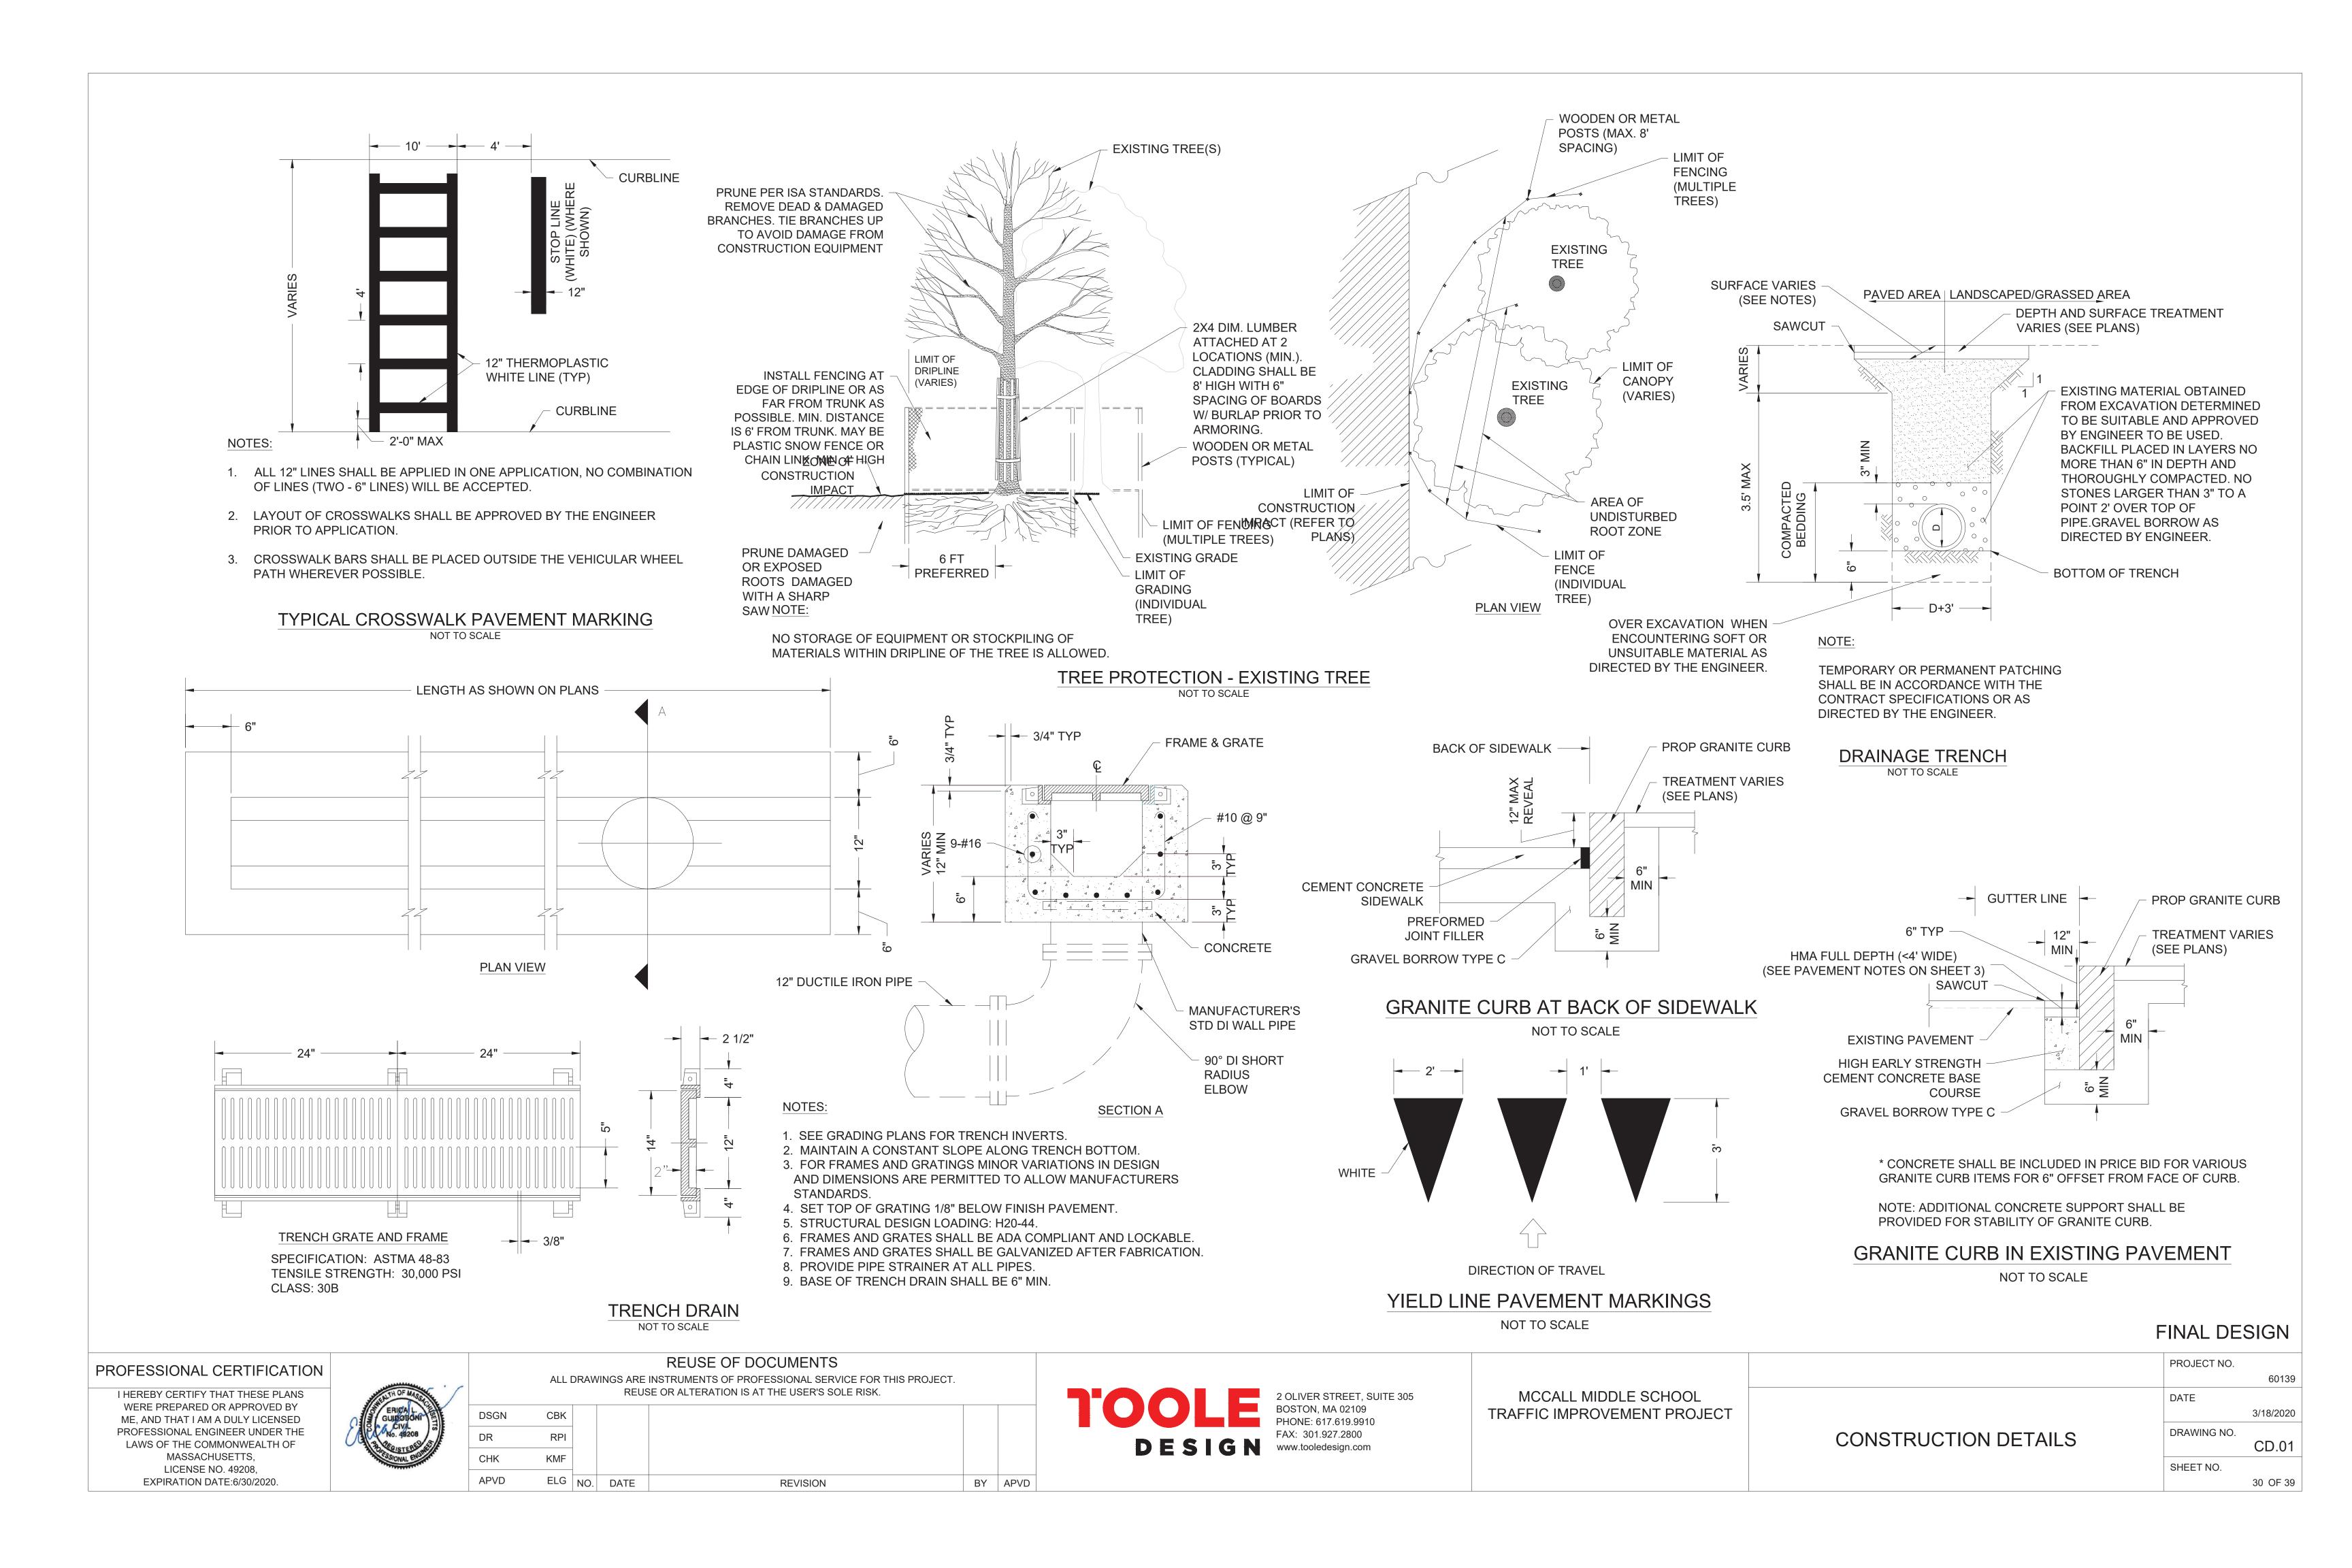
3/18/2020

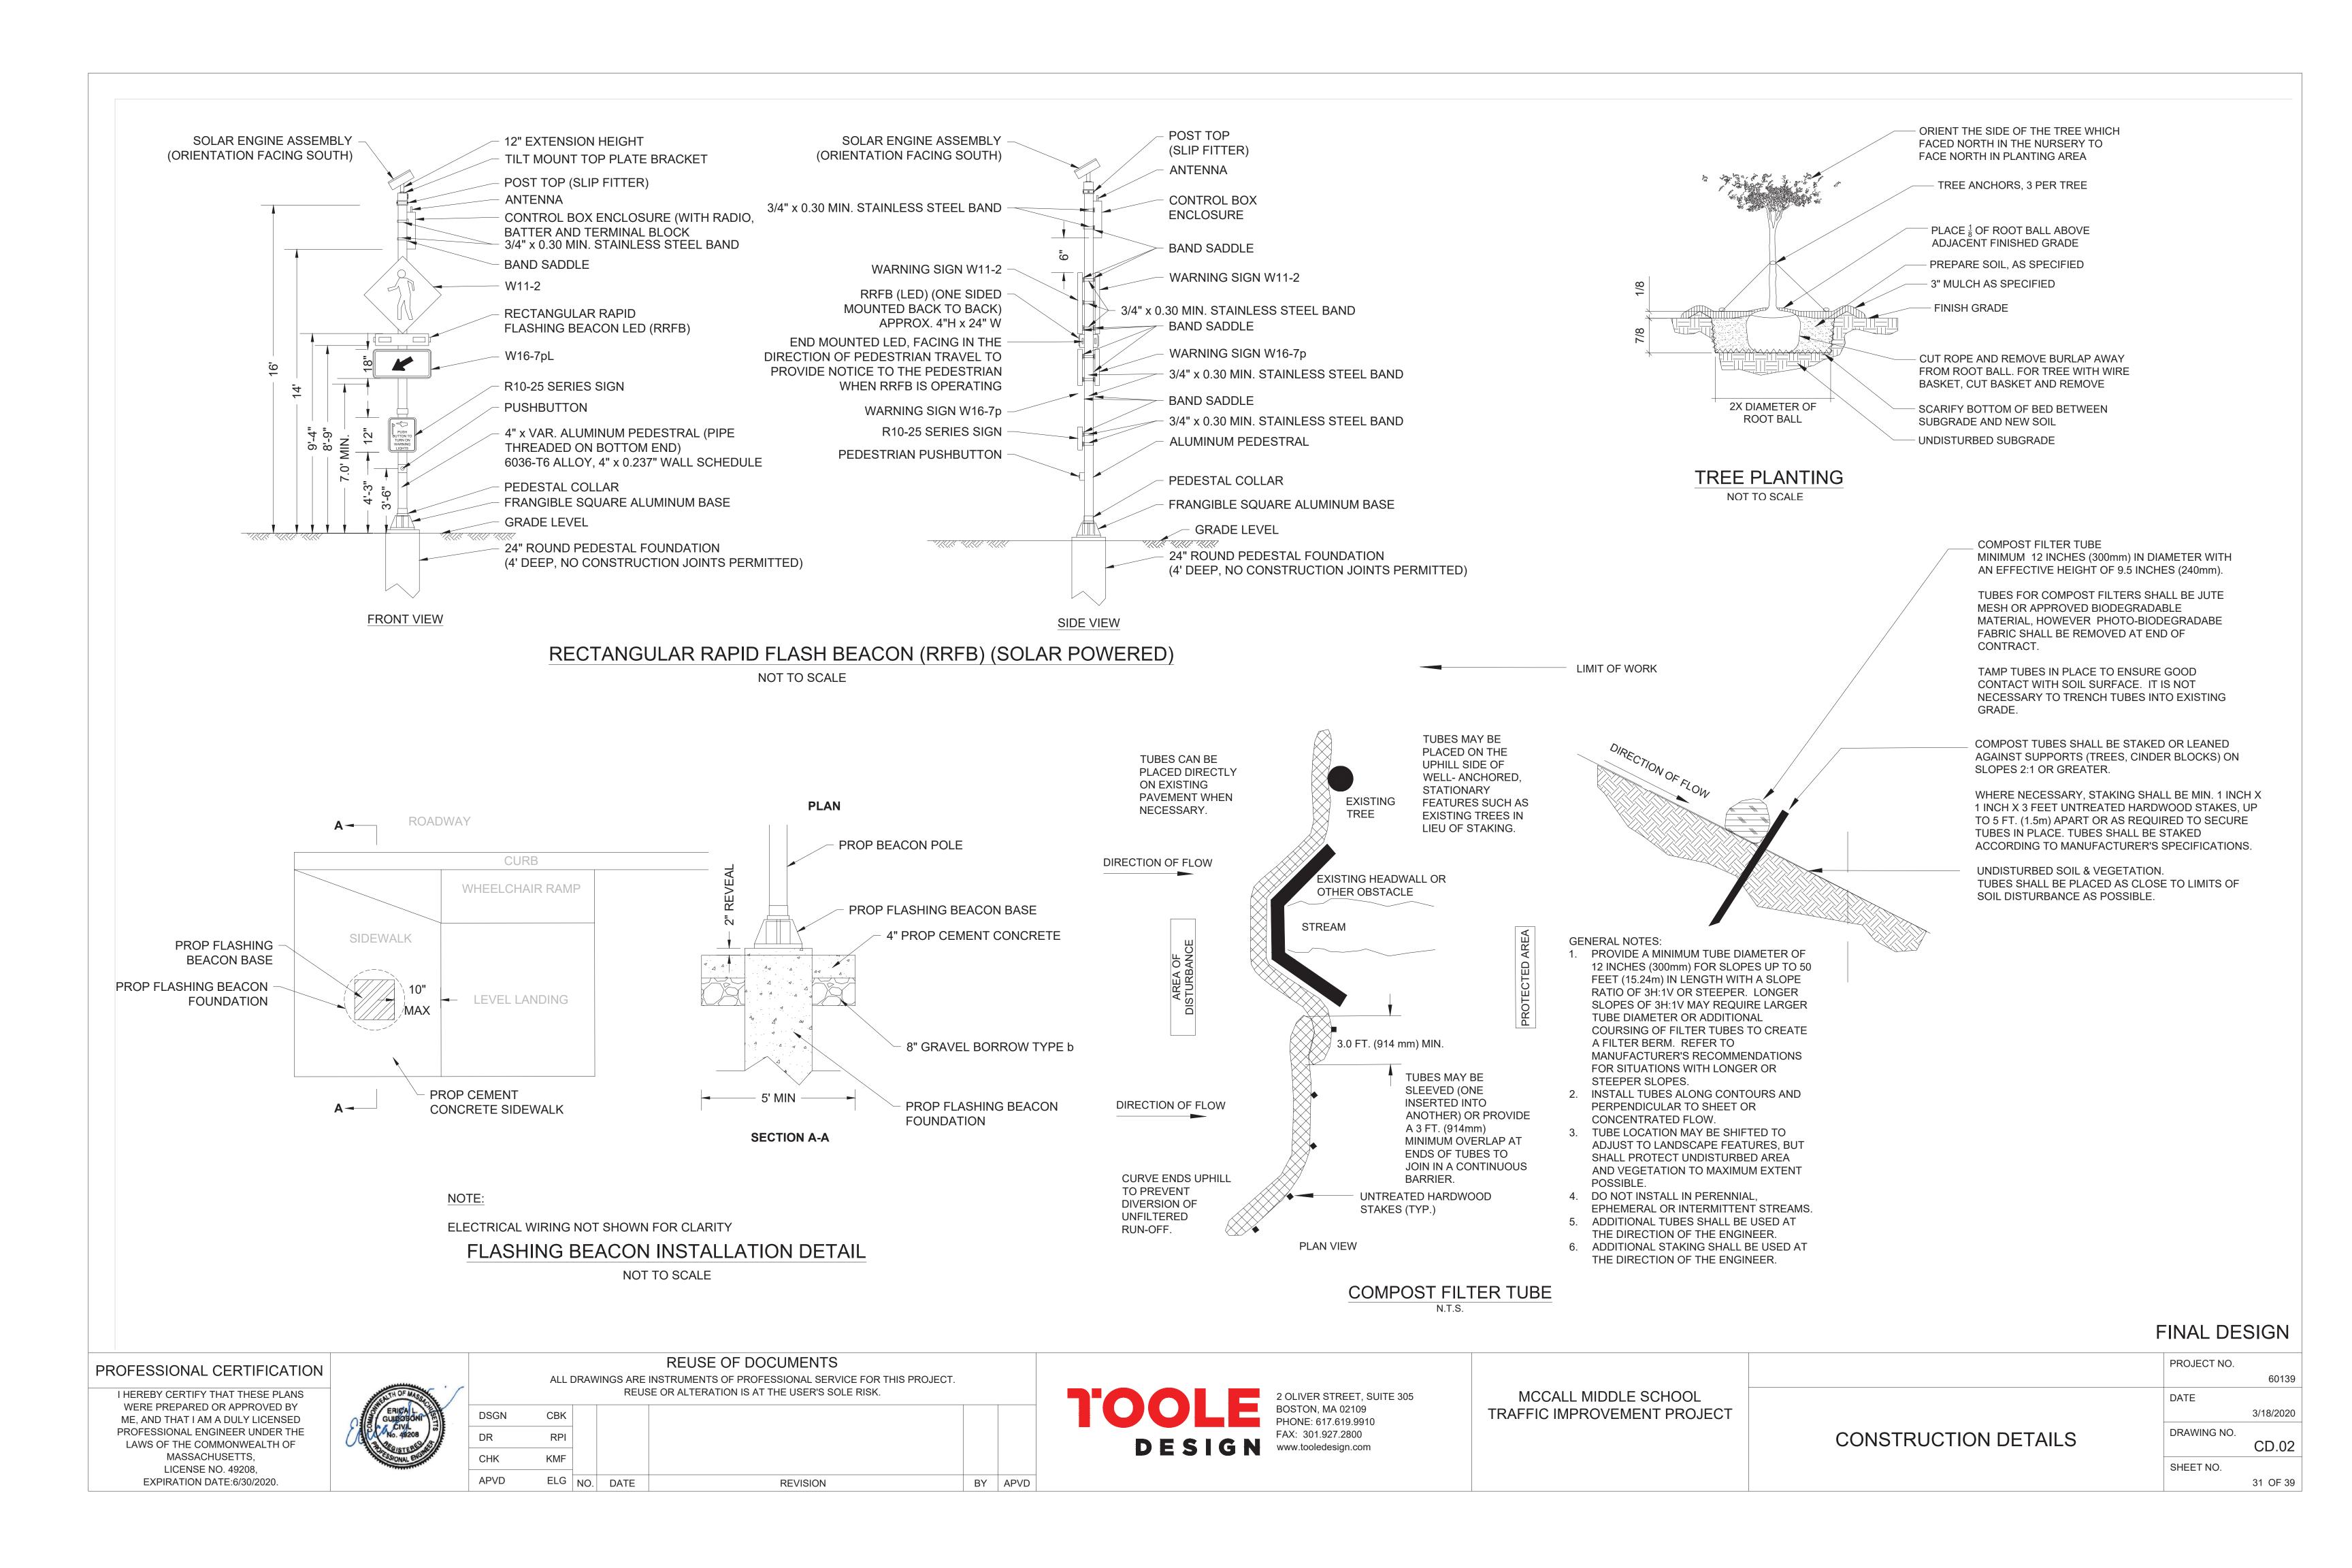
DRAWING NO.

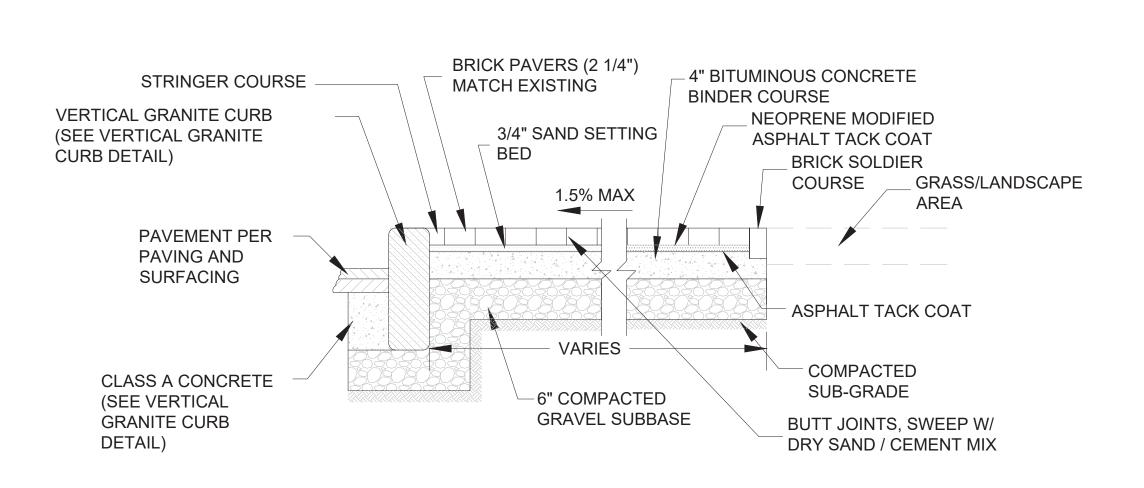
P.01

SHEET NO.

29 OF 39







BRICK SIDEWALK

NOT TO SCALE

2. BITUMINOUS CONCRETE BINDER COURSE SHALL BE 6" DEPTH (IN TWO 3" COURSES) AT DRIVEWAYS. REFER

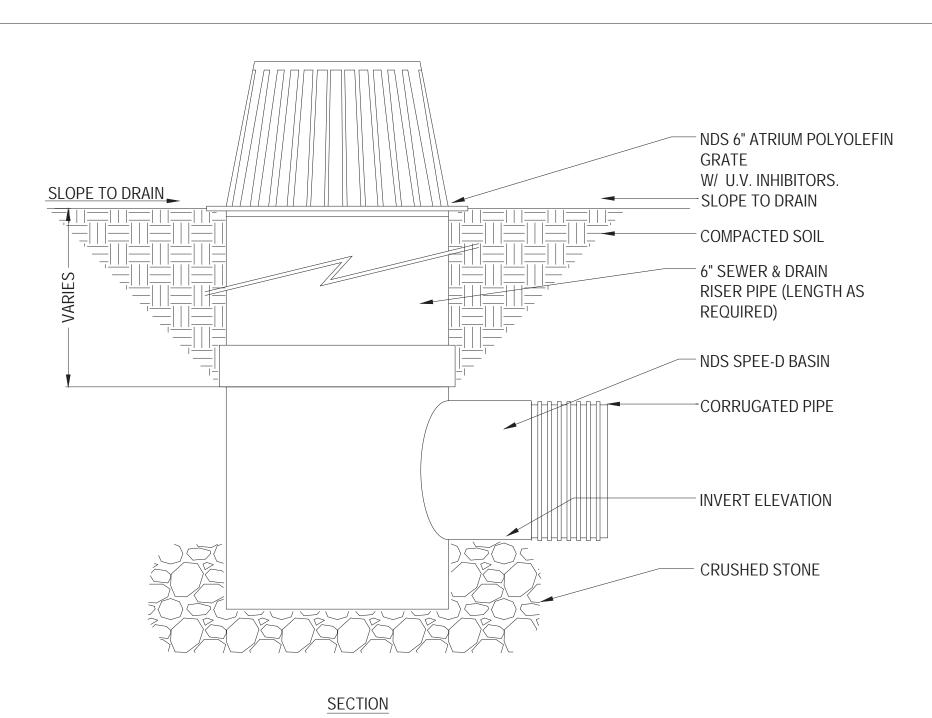
3' ± WIDTH VARIES

INFILTRATION SWALE

NOT TO SCALE

1. SIDEWALKS SHALL MATCH WIDTH AND SLOPE OF EXISTING SIDEWALKS UNLESS OTHERWISE NOTED.

TO PROJECT DRAWINGS OR ENGINEER'S INSTRUCTIONS FOR LOCATIONS




SCOPPED GRANITE

SUBBASE


DRAINS TO BIOSWALE

- 1. INSTALLATION TO BE COMPLETED IN ACCORDANCE WITH MANUFACTURER'S SPECIFICATIONS.
- 2. DO NOT SCALE DRAWING.
- 3. THIS DRAWING IS INTENDED FOR USE BY ARCHITECTS, ENGINEERS, CONTRACTORS, CONSULTANTS AND DESIGN
- PROFESSIONALS FOR PLANNING PURPOSES ONLY.
- 4. ALL INFORMATION CONTAINED HEREIN WAS CURRENT AT THE TIME OF DEVELOPMENT BUT MUST BE REVIEWED AND APPROVED BY THE PRODUCT MANUFACTURER TO BE CONSIDERED ACCURATE.
- 5. CONTRACTOR'S NOTE: FOR PRODUCT AND COMPANY INFORMATION VISIT www.caddetails.com/info AND ENTER REFERENCE NUMBER 558-210.

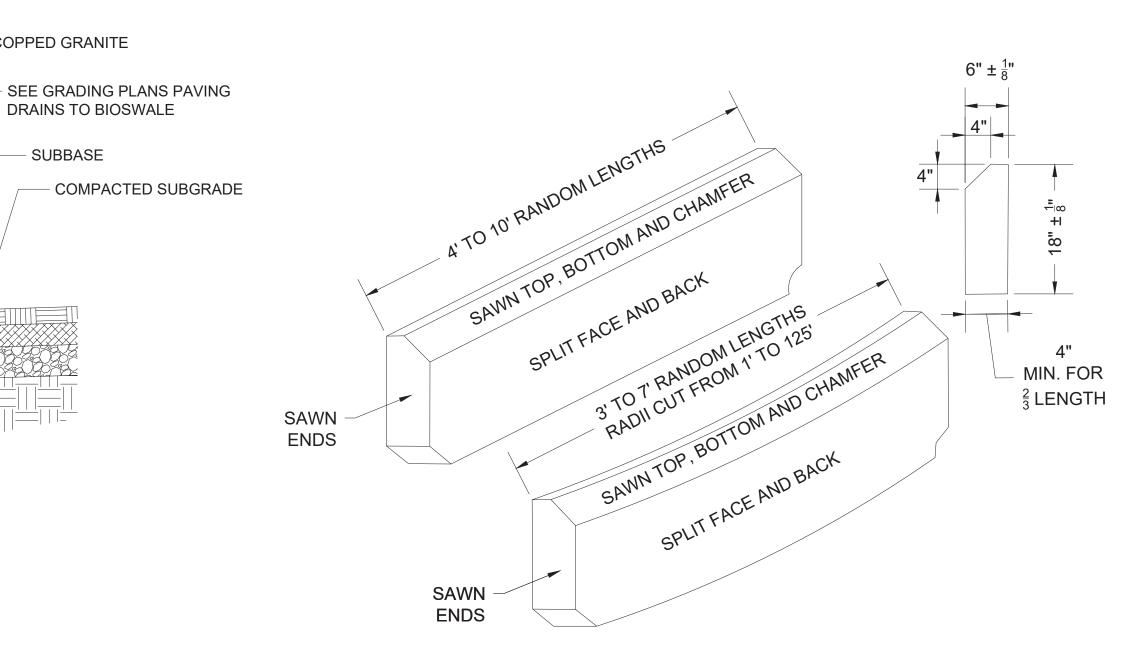AREA DRAIN NOT TO SCALE



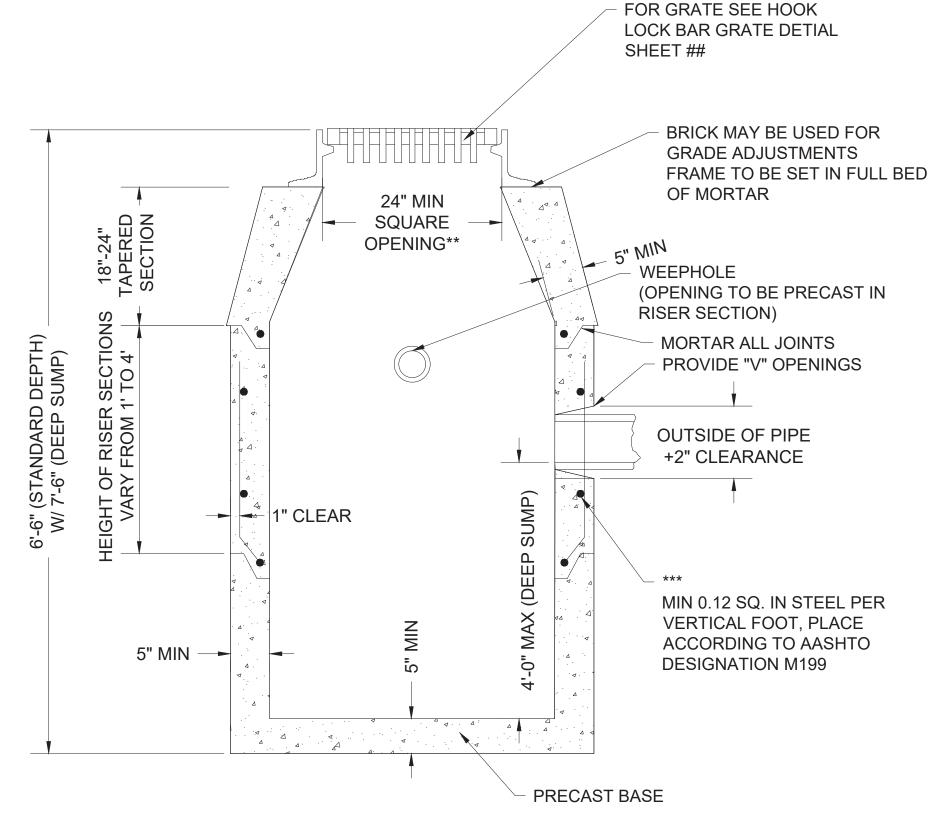6" X 18" MOUNTABLE GRANITE CURBING STRAIGHT AND RADIUS



PRECAST CONCRETE CATCH BASIN NOT TO SCALE

- MINIMUM DEPTH OF SUMP TO BE 2 FT
- ** WHEN A CURB INLET IS INSTALLED, THE OPENING IS TO BE 24"±1"X27"±1"
- *** REINFORCING STEEL BASED ON A WALL THICKNESS OF 5"

NOTES:

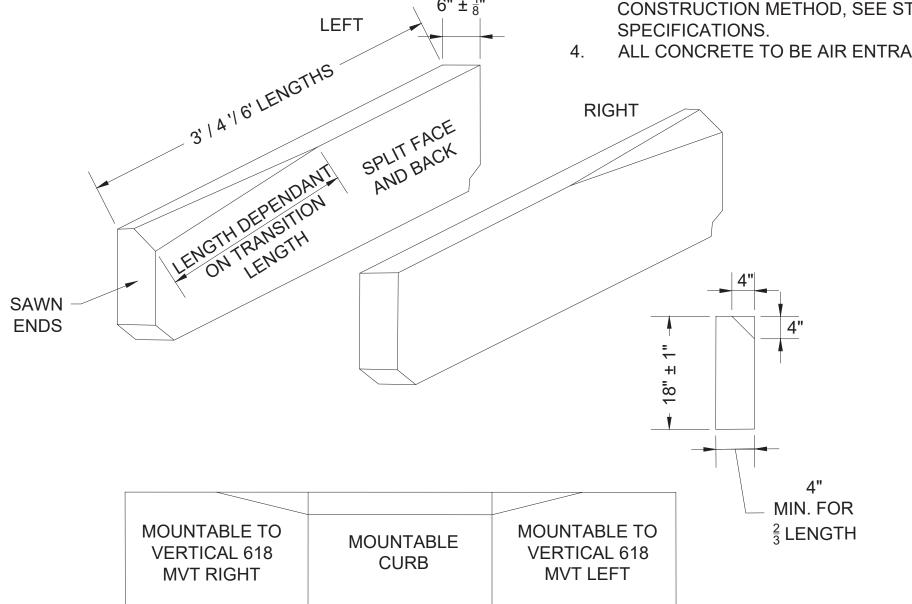
DETAILS NOT INDICATED ABOVE ARE TO BE SIMILAR TO THOSE SHOWN ON E 201.3.0 FACE OF PIPE FLUSH OR NOT TO PROJECT

MORE THAN 4" FROM FACE OF WALL ALONG

FINAL DESIGN

- FOR DESCRIPTION, MATERIALS AND CONSTRUCTION METHOD, SEE STANDARD
- 4. ALL CONCRETE TO BE AIR ENTRAINED.

CENTERLINE OF PIPE



6" X 18" MOUNTABLE TO VERTICAL TRANSITION CURB STRAIGHT AND RADIUS NOT TO SCALE

PROFESSIONAL CERTIFICATION

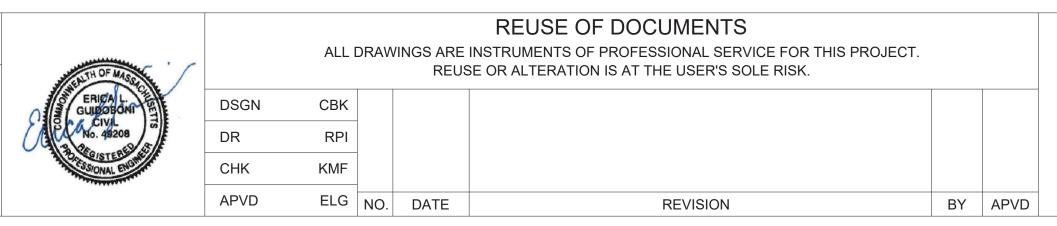
FILTER FABRIC

(50% SAND, 25% COMPOST, 25% TOP SOIL)

18" OF BIOSWALE MIX

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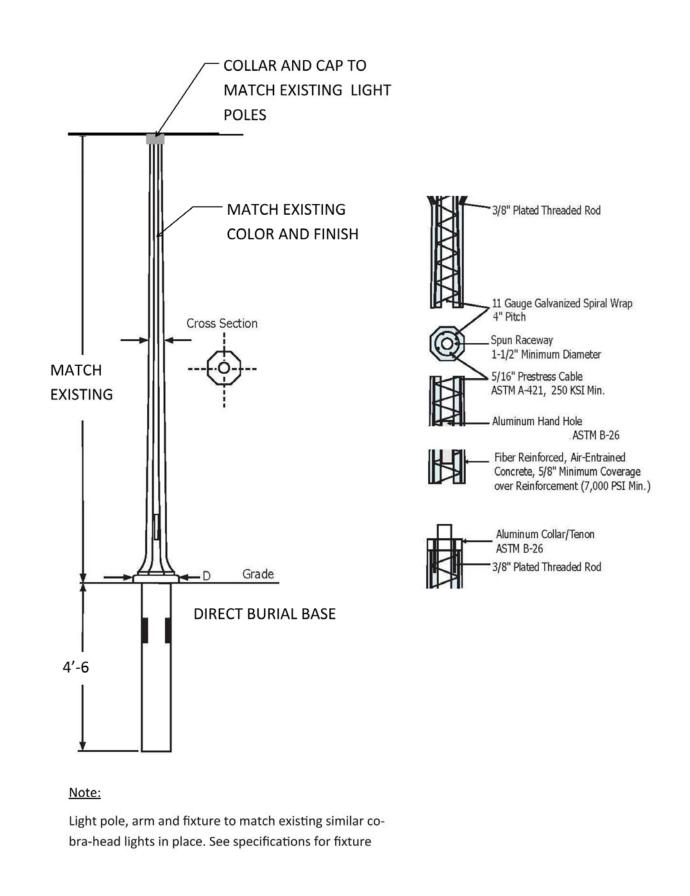
EXPIRATION DATE:6/30/2020.







MCCALL MIDDLE SCHOOL TRAFFIC IMPROVEMENT PROJECT	
	CONSTRU

	PROJECT NO.	
		60139
	DATE	
		3/18/2020
CONSTRUCTION DETAILS	DRAWING NO.	
CONSTRUCTION DETAILS		CD.03
	SHEET NO.	
		32 OF 39





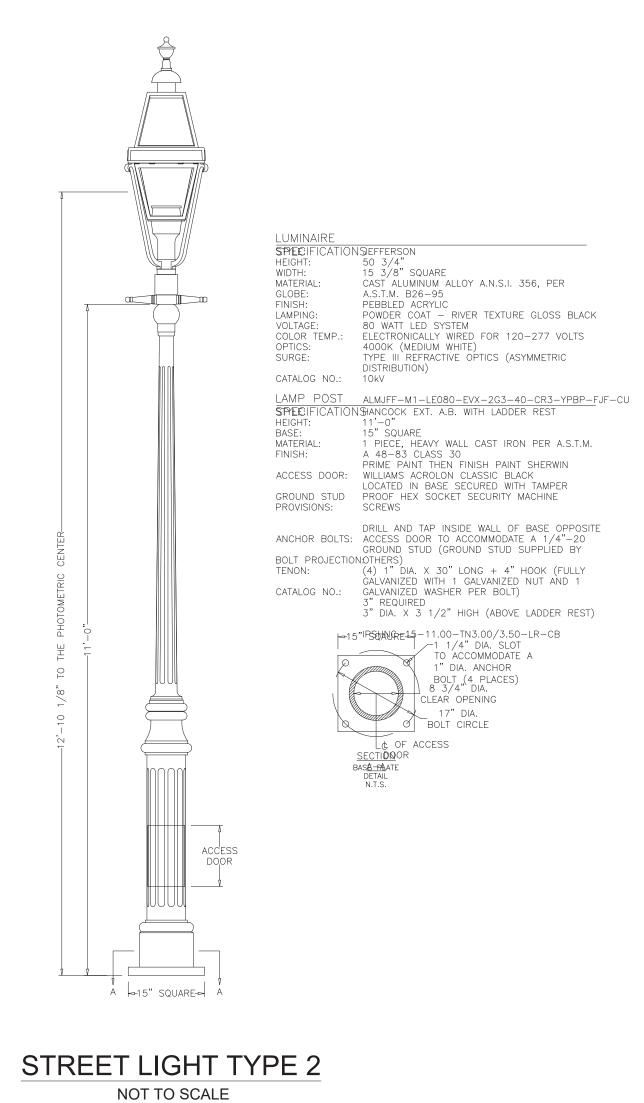

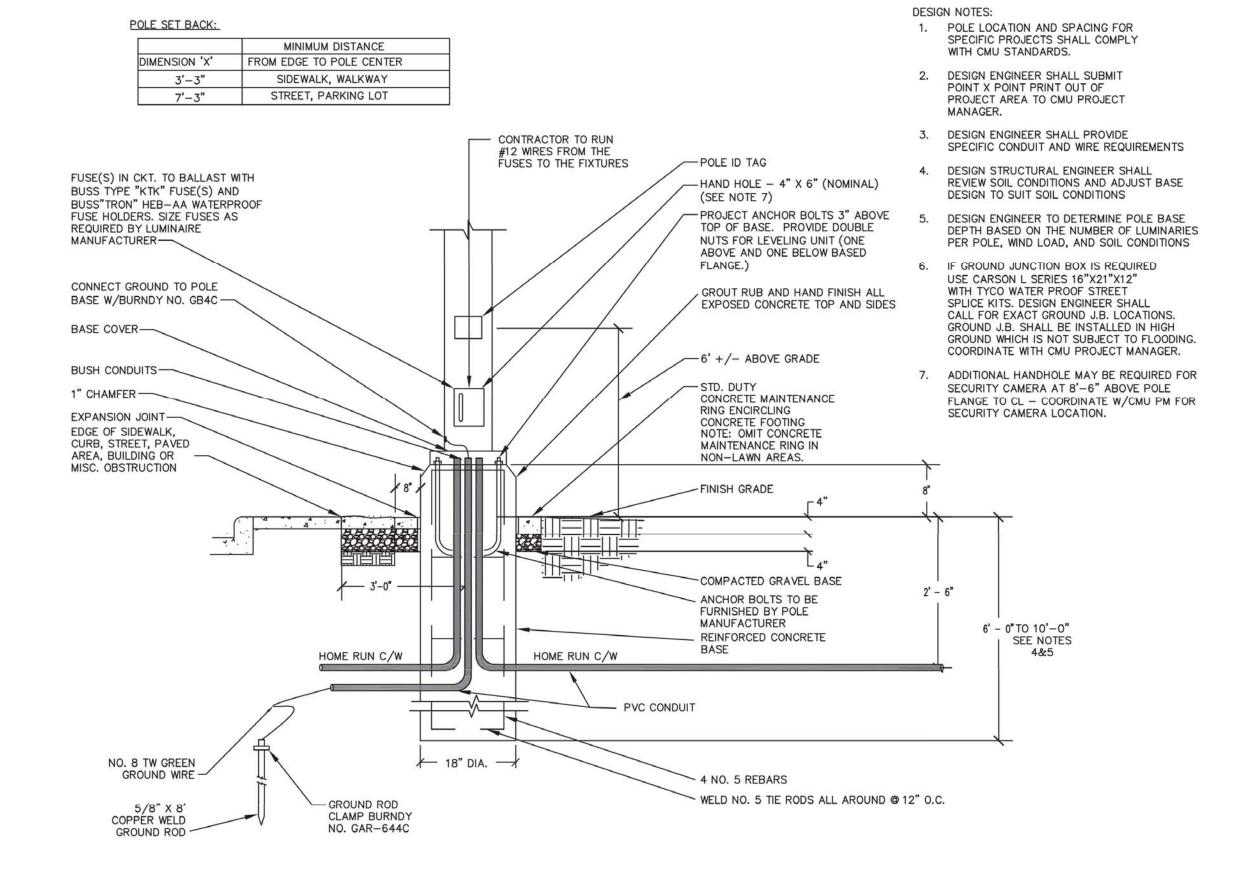

LIGHT BASE DETAIL - STREET LIGHT TYPE 2


NOT TO SCALE

PROFESSIONAL CERTIFICATION

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	DSGN	СВК											
5 M	DR	RPI											
A. C.	CHK	KMF											
	APVD	ELG	NO.	DATE	REVISION	BY	APVD						



MCCALL MIDDLE SCHOOL TRAFFIC IMPROVEMENT PROJECT	
	CONSTRUCTION DETAILS

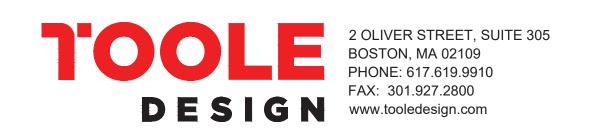FINAL DESIGN

60139

3/18/2020

CD.04

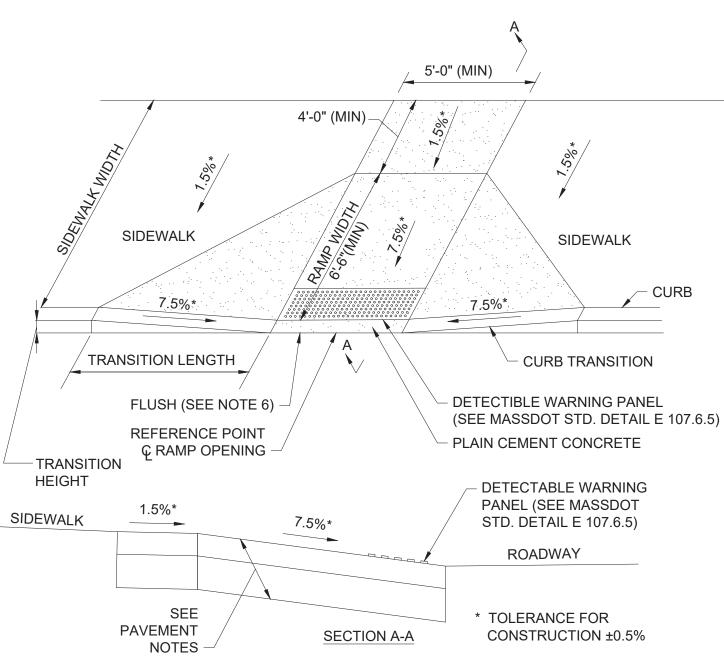
33 OF 39

PROJECT NO.

DRAWING NO.

SHEET NO.

DATE





WHEELCHAIR RAMPS GREATER THAN 12'-4" SIDEWALK TYPE A


NOT TO SCALE

WHEELCHAIR RAMP NOTES:

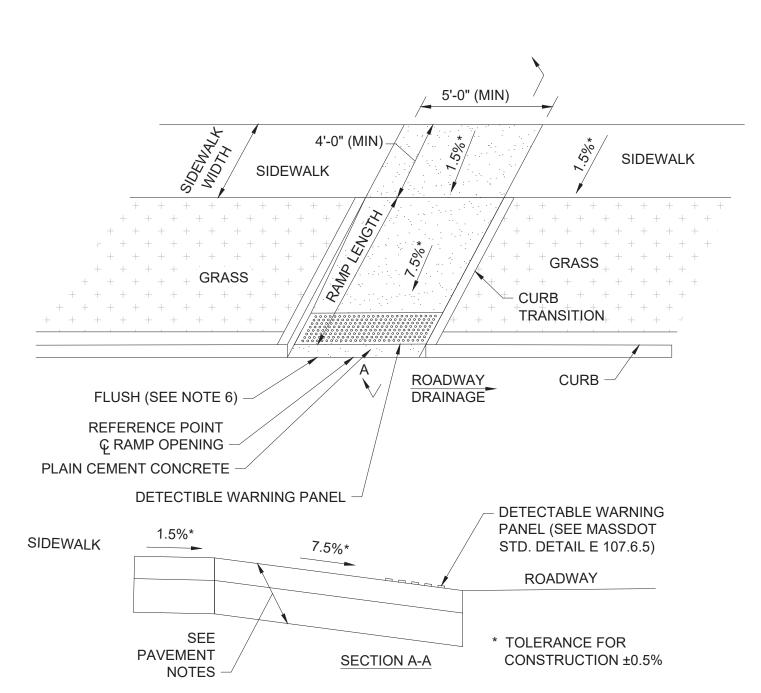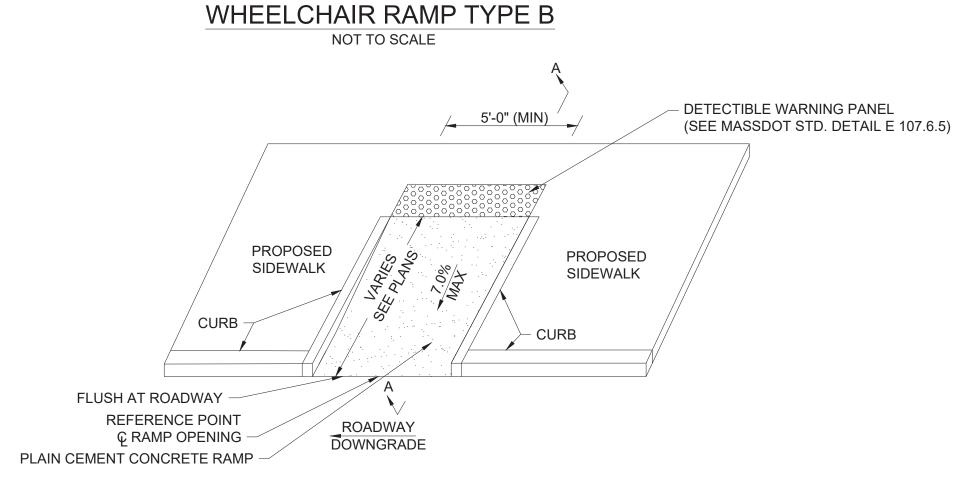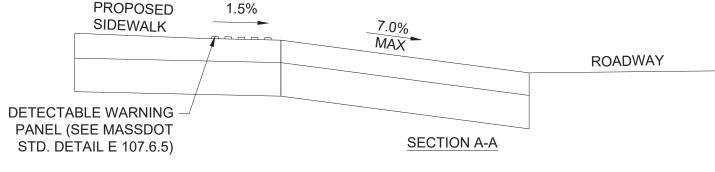- 1. MAXIMUM ALLOWABLE SLOPE OF ACCESSIBLE ROUTE EXCLUDING CURB RAMPS SHALL BE DESIGNED TO 4.5% ±0.5% (7.5% ±0.5% FOR CURB RAMPS)
- 2. A MINIMUM OF 3'-3" CLEAR SHALL BE MAINTAINED AT ANY PERMANENT OBSTACLE IN ACCESSIBLE ROUTE (I.E., HYDRANTS, UTILITY POLES, TREE WELLS, SIGNS, ETC.).
- 3. CURB TREATMENT VARIES, SEE PLANS FOR CURB TYPE.
- 4. RAMP, CURB AND ADJACENT PAVEMENTS SHALL BE GRADED TO PREVENT PONDING.
- 5. WHERE ACCESSIBLE ROUTES ARE LESS THAN 5' IN WIDTH (EXCLUDING CURBING) A 5'x5' PASSING AREA SHALL BE PROVIDED AT INTERVALS NOT TO EXCEED 200 FT.
- 6. ELIMINATE CURBING AT RAMP WHERE IT ABUTS ROADWAY.
- 7. DETECTABLE WARNING PANELS ARE REQUIRED ON ALL OF THE PROPOSED WHEELCHAIR RAMPS AND ARE TO BE INSTALLED IN ACCORDANCE WITH CONSTRUCTION STANDARD E 107.6.5 (DECEMBER 2016). CONTRACTOR SHALL PROVIDE 6" BETWEEN DETECTABLE WARNING PANEL AND EDGE OF CONCRETE WHERE IT ABUTS LOAM & SEED.
- 8. ALL DETECTABLE WARNING PANELS SHALL BE RED.
- 9. WHEELCHAIR RAMP SLOPES AND CROSS SLOPES SHALL HAVE A CONSTRUCTION TOLERANCE OF ±0.5%.







BICYCLE RAMP DETAIL

N.T.S.

ROADWAY PROFILE GRADE	HIGH SIDE TRANSITION LENGTH*
=0%	6'-6"
>0% TO 1%	7'-8"
>1% TO 2%	9'-0"
>2% TO 3%	11'-0"
>3% TO 4%	14'-0"
>4% TO 5%	15'-0" MAX

CURB TRANSITION LENGTH FOR WHEELCHAIR RAMPS

* <u>NOTE:</u>
BASED ON A DESIGN SLOPE OF 7.5%
AND REVEAL OF 6".

			W	CR DATA	TABLE - M	IAIN AT WA	SHINGTO	N				
		STREET NAME	S/O REF	S/O REFERENCE		ROADWAY	RAMP	SIDEWALK	TRANSITION LEFT		TRANSITION RIGHT	
NUMBER	TYPE		STATION	OFFSET	WIDTH (FT)	GUTTER SLOPE	LENGTH (FT)	WIDTH (FT)	LENGTH (FT)	REVEAL (IN)	LENGTH (FT)	REVEAL (IN)
1	А	MAIN STREET	14+03.24	16.01' LT	5.0	1.4%	9.0	13.0	6.5	5.0	6.5	6.0
2	А	MAIN STREET	13+23.88	16.01' LT	5.0	0.6%	7.5	12.5	6.5	5.3	6.5	6.0
3	В	MT. PLEASANT STREET	20+26.19	12.19'RT	6.0	0.50%	7.7	5.4	N/A	N/A	N/A	N/A
4	А	MT. PLEASANT STREET	20+25.05	11.58' LT	5.0	-1.20%	6.8	VARIES	5.0	6.0	7.0	4.8
5	А	MAIN STREET	13+23.90	15.99' RT	5.0	-1.0%	8.5	VARIES	6.5	6.0	6.5	5.3
6	А	WASHINGTON STREET	30+25.13	18.79' RT	5.0	1.4%	10.8	VARIES	6.6	5.2	10.5	6.0
7	А	WASHINGTON STREET	30+25.13	20.85' LT	5.0	-1.4%	11.5	VARIES	8.8	6.0	7.0	5.0
8	Α	MAIN STREET	14+03.23	16.06' RT	5.0	-1.4%	8.5	VARIES	6.5	6.0	6.7	5.8

			S/O REFERENCE		OPENING	ROADWAY	RAMP	SIDEWALK	TRANSITION LEFT		TRANSITION RIGHT	
NUMBER	TYPE	STREET NAME	STATION	OFFSET	WIDTH (FT)	GUTTER SLOPE	LENGTH (FT)	WIDTH (FT)	LENGTH (FT)	REVEAL (IN)	LENGTH (FT)	REVEAL (IN)
1	А	MYSTIC VALLEY PARKWAY	11+38.72	38.85' RT	5.0	0.6%	8.8	VARIES	6.4	6.0	7.0	5.4
2	А	MYSTIC VALLEY PARKWAY	11+66.25	42.02' RT	5.0	1.2%	8.5	VARIES	6.6	5.8	6.5	6.0
3	А	MYSTIC VALLEY PARKWAY	11+93.53	16.00' RT	5.0	-0.6%	8.5	VARIES	6.5	4.0	7.0	4.0
4	А	MYSTIC VALLEY PARKWAY	11+93.53	16.00' LT	5.0	-0.8%	8.5	VARIES	6.5	4.0	6.5	4.0
5	Α	WATERFIELD ROAD	20+87.80	16.65' RT	6.0	1.5%	6.0	VARIES	7.5	4.0	6.5	4.0
6	Α	WATERFIELD ROAD	20+88.54	16.77' LT	6.0	-1.5%	10.1	VARIES	6.5	4.0	7.4	4.0
7	А	MYSTIC VALLEY PARKWAY	14+50.76	16.90' LT	5.0	0.6%	9.7	VARIES	6.5	4.0	8.9	4.0
8	А	MYSTIC VALLEY PARKWAY	14+54.62	26.16' RT	5.0	1.4%	8.7	VARIES	6.9	4.0	6.7	4.0

	BICYCLE RAMP DATA TABLE - MAIN AT WASHINGTON												
			S/O REFERENCE		OPENING	ROADWAY	RAMP	SIDEWALK	TRANSITION LEFT		TRANSITION RIGHT		
NUMBER	TYPE	STREET NAME	STATION	OFFSET	WIDTH (FT)	GUTTER SLOPE	LENGTH (FT)	WIDTH (FT)	LENGTH (FT)	REVEAL (IN)	LENGTH (FT)	REVEAL (IN)	
1	BR	MAIN STREET	12+94.34	16.32' LT	5.0	-0.6%	8.0	VARIES	N/A	N/A	N/A	N/A	
2	BR	MAIN STREET	10+47.85	19.44' LT	6.0	-1.50%	8.8	VARIES	N/A	N/A	N/A	N/A	

FINAL DESIGN

PROFESSIONAL CERTIFICATION


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EXPIRATION DATE:6/30/2020.




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	DSGN	СВК						
15	DR	RPI						
5/F	CHK	KMF						
	APVD	ELG	NO.	DATE	REVISION	BY	APVD	



		PROJECT NO.	
			60139
MCCALL MIDDLE SCHOOL		DATE	
TRAFFIC IMPROVEMENT PROJECT			3/18/2020
	WHEEL CHAID DAMD DETAILS	DRAWING NO.	
	WHEELCHAIR RAMP DETAILS		CD.05
		SHEET NO.	
			34 OF 39

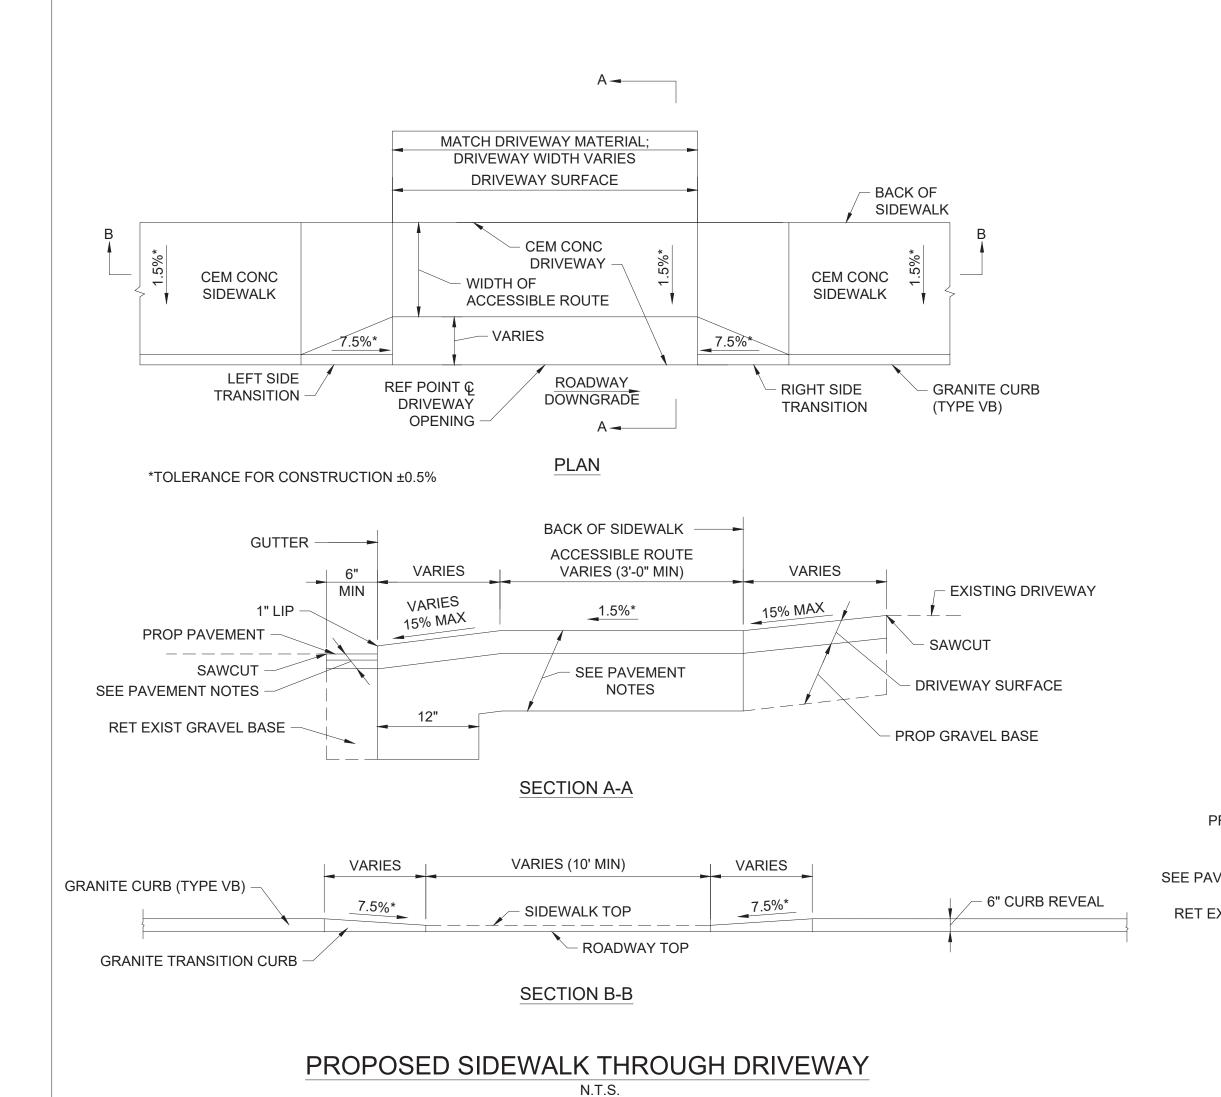

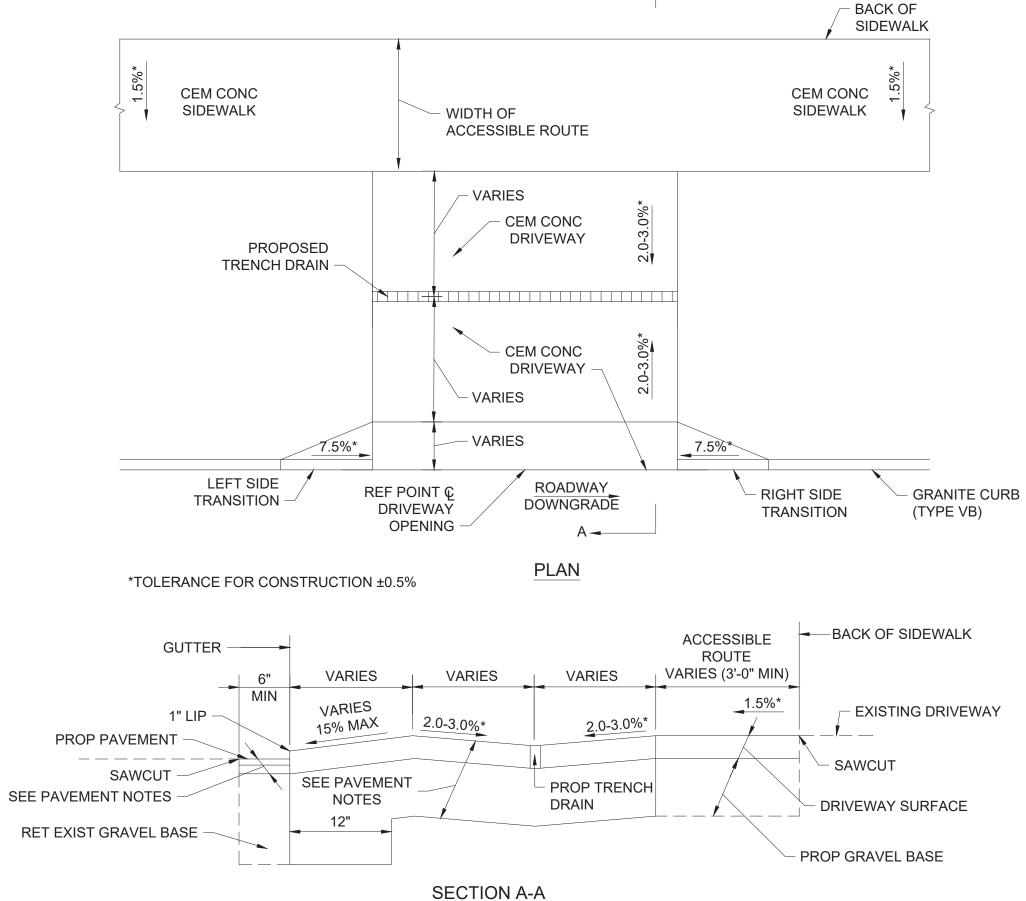

PROPOSED SIDEWALK THROUGH DRIVEWAY WITH TRENCH DRAIN

N.T.S.

					DRIVEWA	Y DATA						
		DRIVEWAY	DRIVEWAY REFERENCE		WIDTH	ROADWAY GUTTER	WIDTH OF	WIDTH OF ACESSIBLE	TRANSITION LEFT		TRANSITION RIGHT	
NUMBER	STREET NAME	SURFACE	STATION	OFFSET	(FT)	SLOPE	SW (FT)	ROUTE	LENGTH	REVEAL	LENGTH	REVEAL
1	MAIN STREET	CEM CONC	11+60.29	16.18' RT	15.9	-0.94%	11.1	7.2	3.9	4.0	6.5	4.8
2	WASHINGTON STREET	CEM CONC	30+84.92	15.75' RT	13.4	2.98%	6.0	6.0	6.5	5.0	6.5	4.4
3	WASHINGTON STREET	CEM CONC	31+93.91	23.36' RT	10.0	2.47%	5.6	5.6	N/A	6.0	N/A	6.0
1	MYSTIC VALLEY PARKWAY	CEM CONC	12+24.26	16.00' RT	25.5	0.67%	6.7	6.7	6.0	4.0	5.2	4.6

FINAL DESIGN

PROFESSIONAL CERTIFICATION

I HEREBY CERTIFY THAT THESE PLANS WERE PREPARED OR APPROVED BY ME, AND THAT I AM A DULY LICENSED PROFESSIONAL ENGINEER UNDER THE LAWS OF THE COMMONWEALTH OF MASSACHUSETTS, LICENSE NO. 49208, EXPIRATION DATE:6/30/2020.



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		PROJECT NO.	
			60139
MCCALL MIDDLE SCHOOL		DATE	
TRAFFIC IMPROVEMENT PROJECT			3/18/2020
		DRAWING NO.	
	DRIVEWAY DETAILS		CD.06
		SHEET NO.	
			35 OF 39

→ DRIVEWAY WIDTH VARIES →

SIDEWALK

RADIUS VARIES

VARIES

15% MAX

PROP GRANITE CURB CORNER (TYP)

SEE ALIGNMENT PLANS FOR RADIUS

EDGE OF ROADWAY

EXISTING DRIVEWAY

SAWCUT

NOTE:

DRIVEWAY SURFACE

- PROP GRAVEL BASE - 8" MIN

W = SIDEWALK WIDTH

CC = CEMENT CONCRETE

HMA = HOT MIX ASPHALT

* CONSTRUCTION TOLERANCE ±0.5%

HSL = HIGH SIDE TRANSITION LENGTH

SAWCUT

REFERENCE

POINT

BACK OF SIDEWALK ──►

ACCESSIBLE ROUTE

VARIES (3'-0" MIN)

1.5%*

SECTION A-A

PROPOSED SIDEWALK THROUGH DRIVEWAYS

WITH CURB RETURNS - MODIFIED E 107.8.0

SEE PAVEMENT

NOTES

ROADWAY

DOWNGRADE

BACK OF SIDEWALK LINE

SIDEWALK 5%

GUTTER -

PROP PAVEMENT -

RET EXIST GRAVEL BASE

SAWCUT

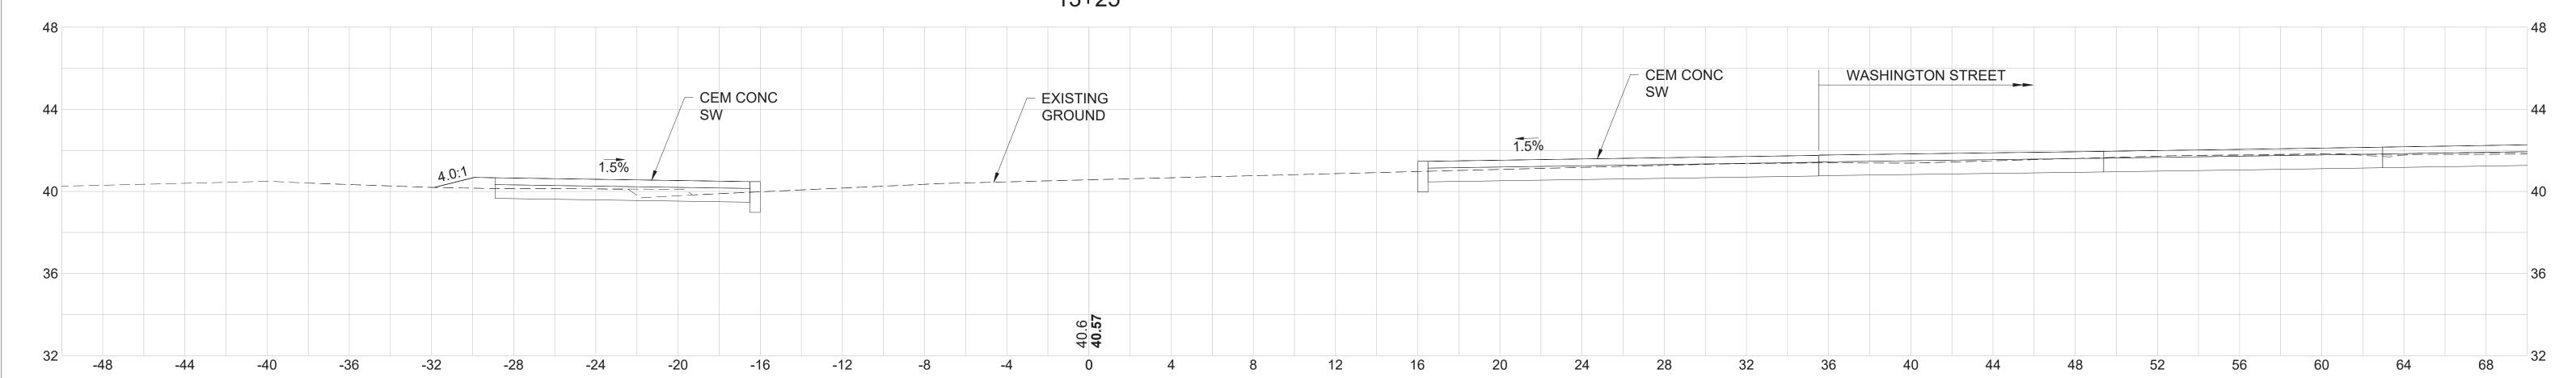
RADIUS VARIES

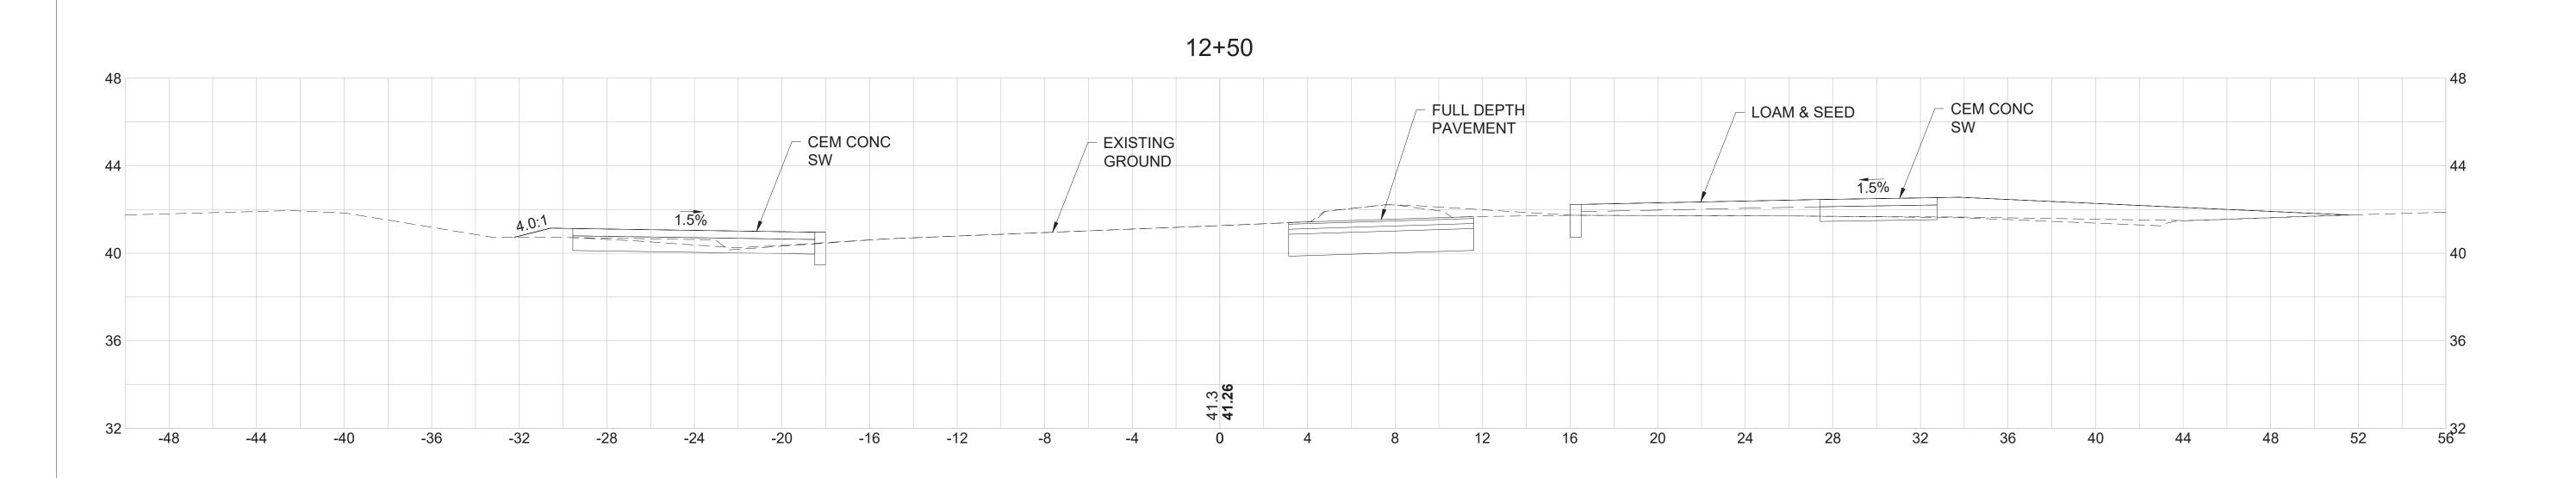
5% TO 15%

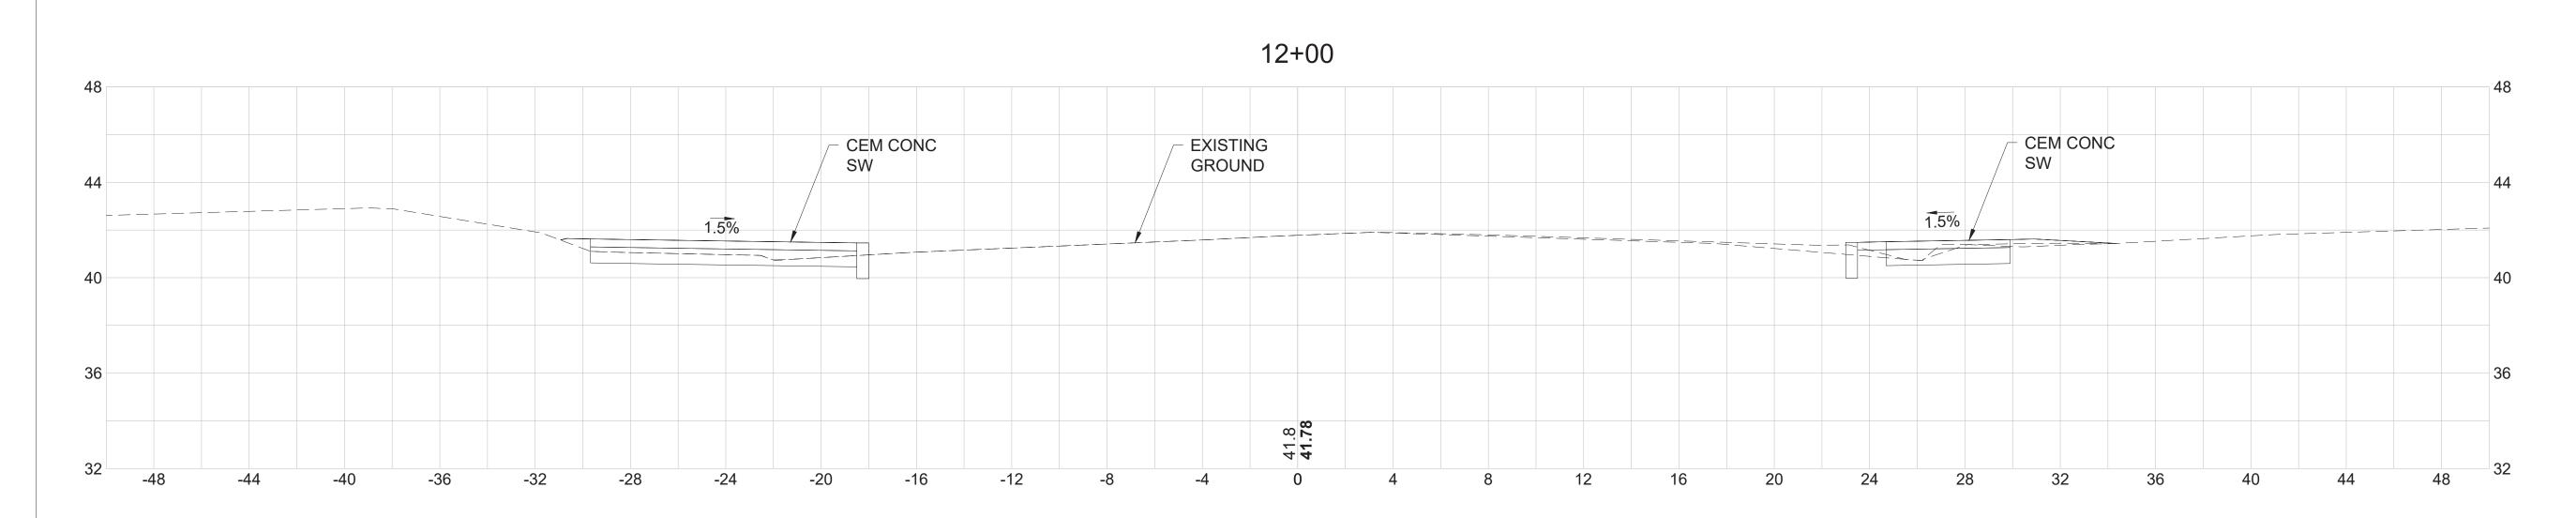
SLOPE

MAIN STREET

13+25







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2 OLIVER STREET, SUITE 305 BOSTON, MA 02109 PHONE: 617.619.9910 FAX: 301.927.2800 www.tooledesign.com

MCCALL MIDDLE SCHOOL TRAFFIC IMPROVEMENT PROJECT

	DATE
MAIN STREET AT WASHINGTON STREET CRITICAL CROSS SECTIONS	DRAWING NO
	SHEET NO.

FINAL DESIGN

3/18/2020

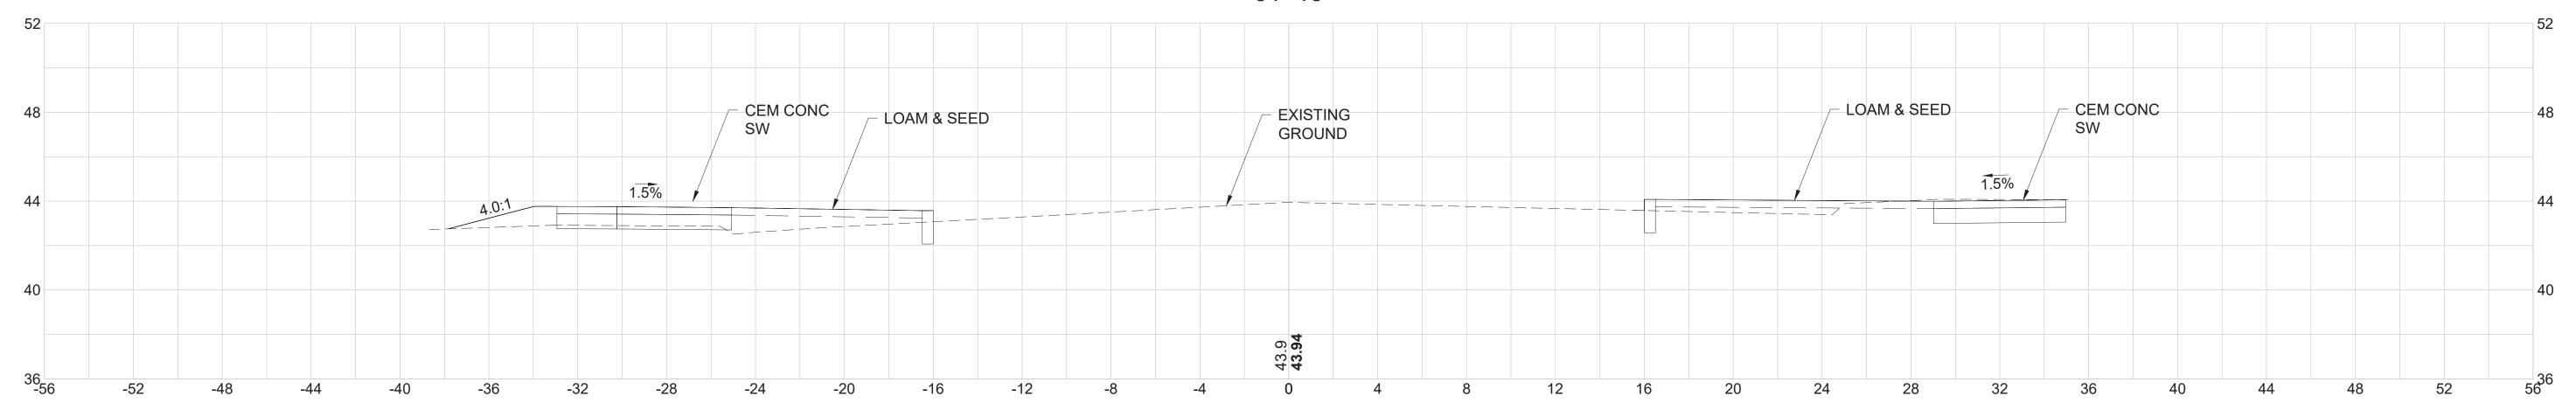
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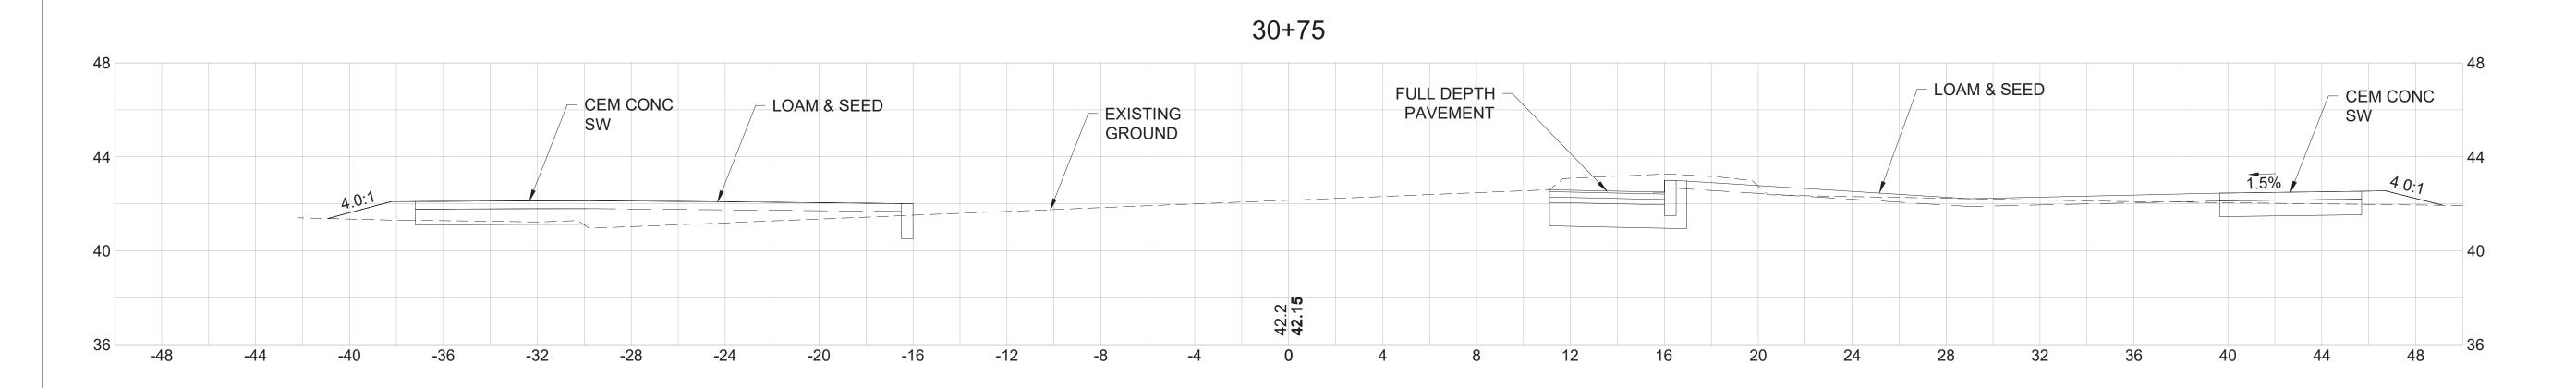
36 OF 39

PROJECT NO.

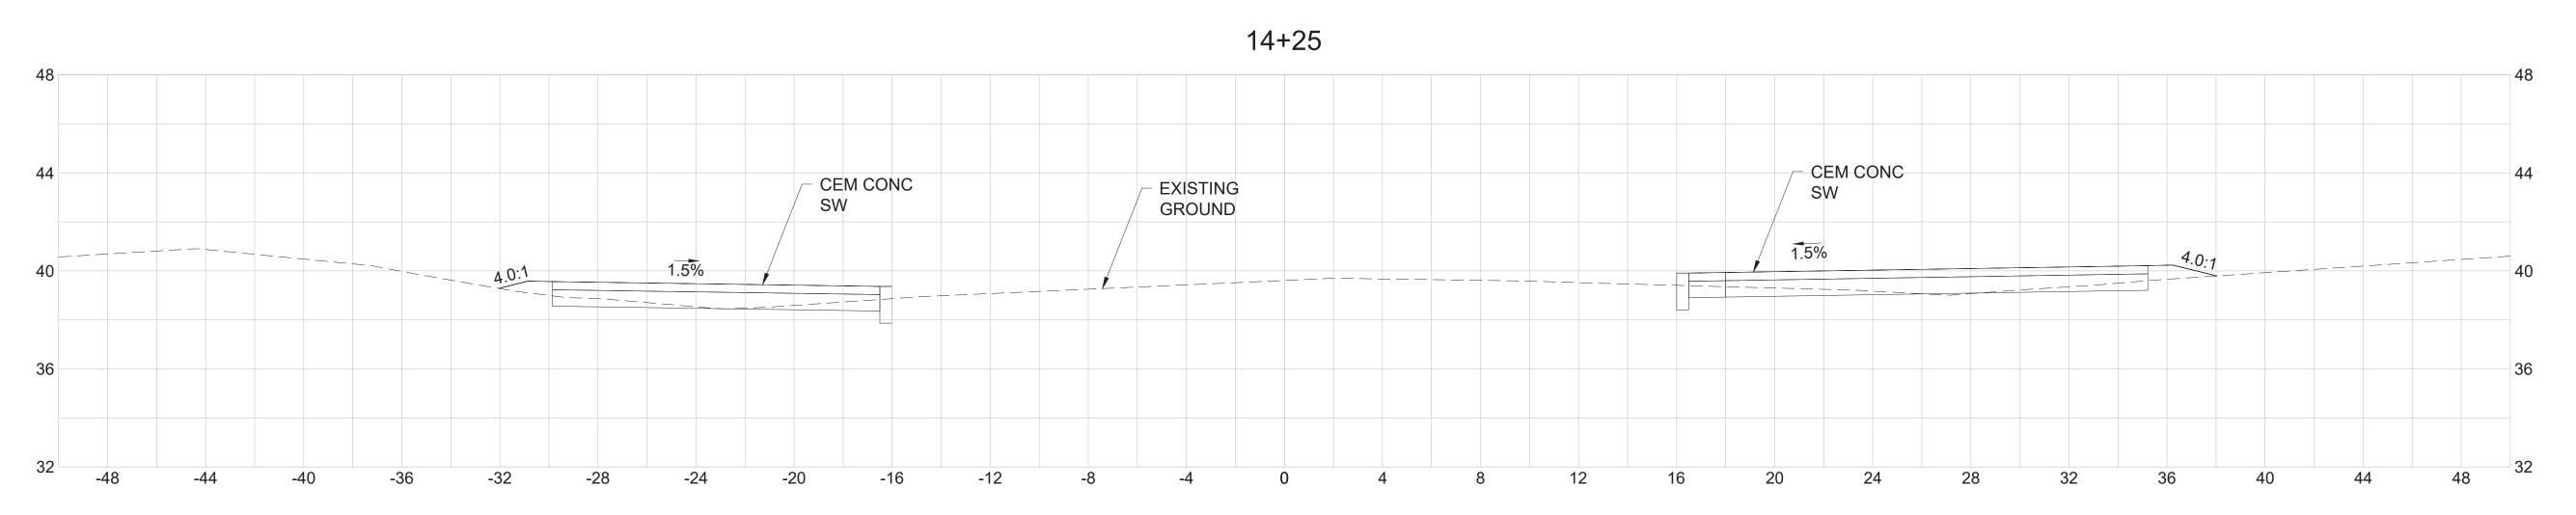
WASHINGTON STREET

31+15





MAIN STREET



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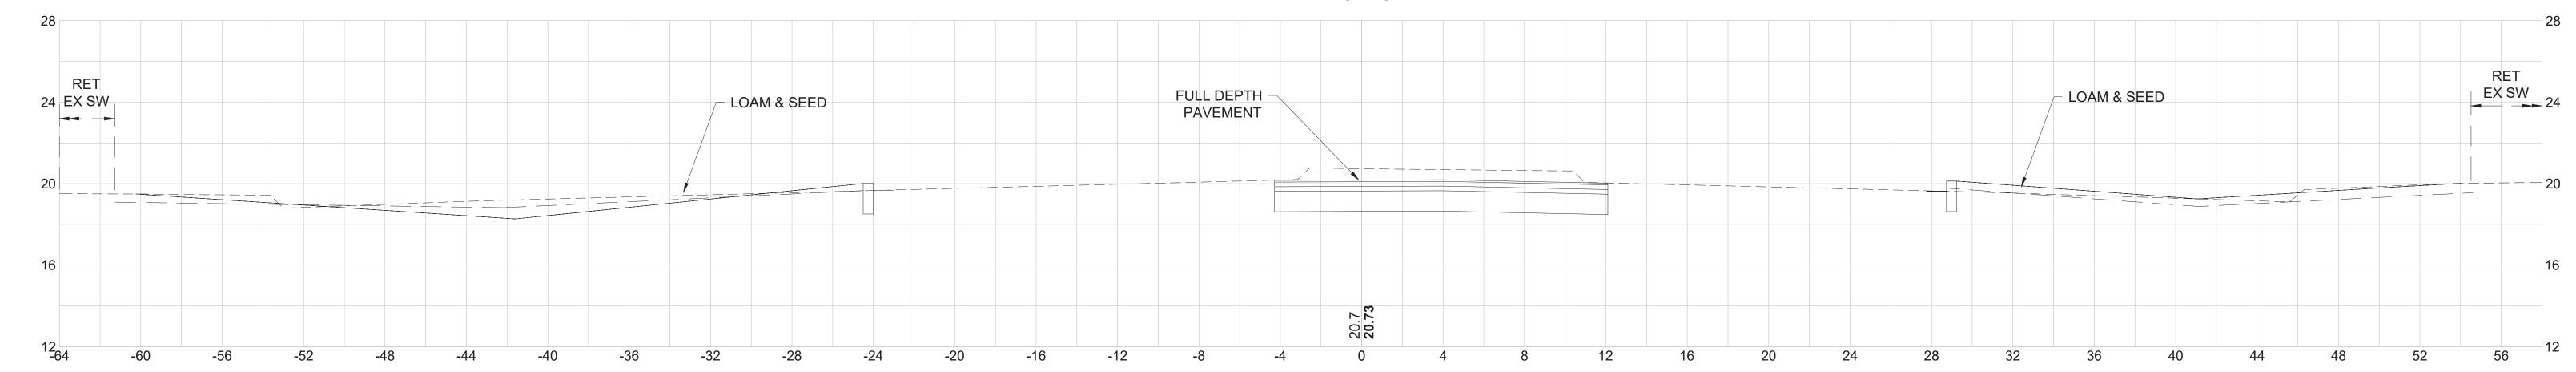
	DATE
MAIN STREET AT WASHINGTON STREET CRITICAL CROSS SECTIONS	DRAWIN
	SHEET


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		60139
	DATE	
		3/18/2020
REET	DRAWING NO.	
		CS.02
	SHEET NO.	
		37 OF 39


FINAL DESIGN

MYSTIC VALLEY PARKWAY

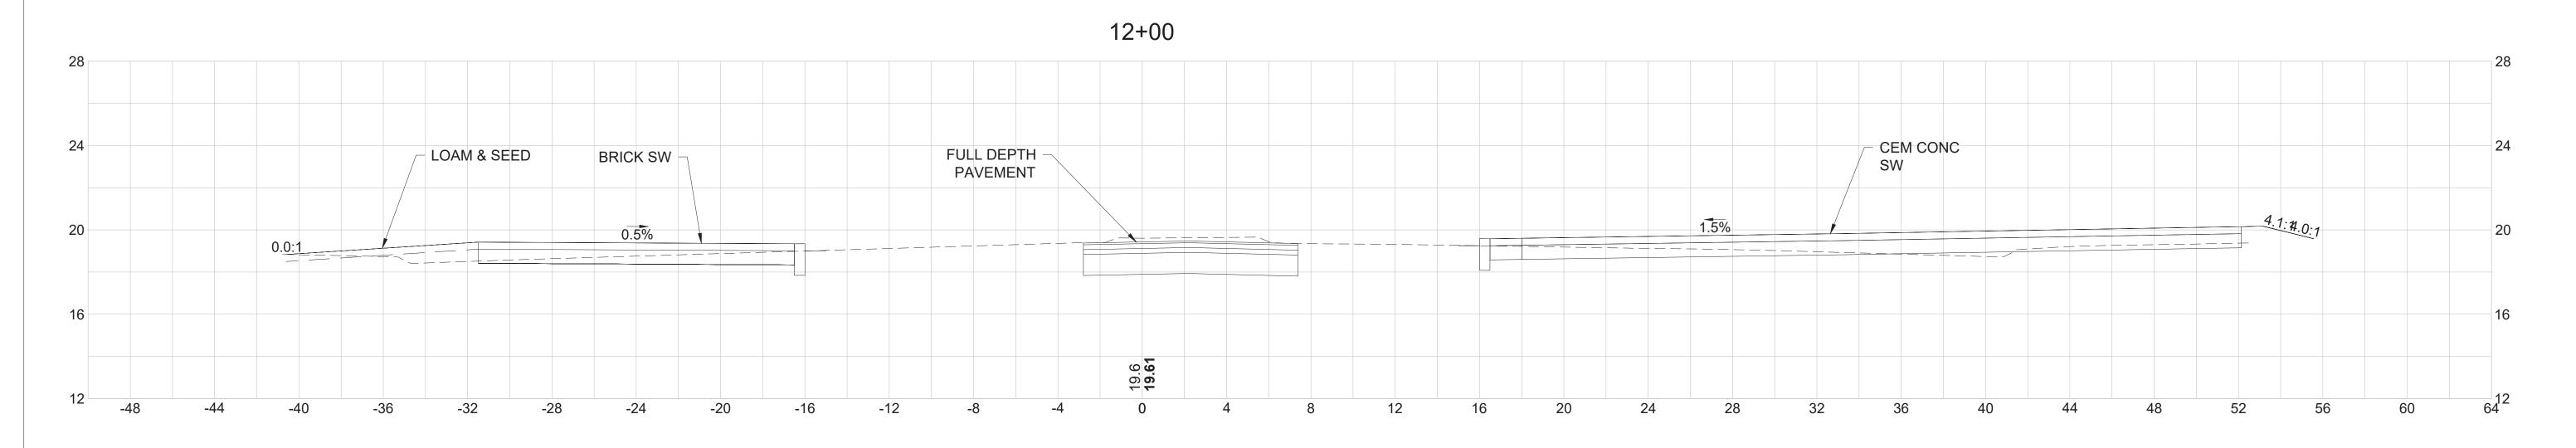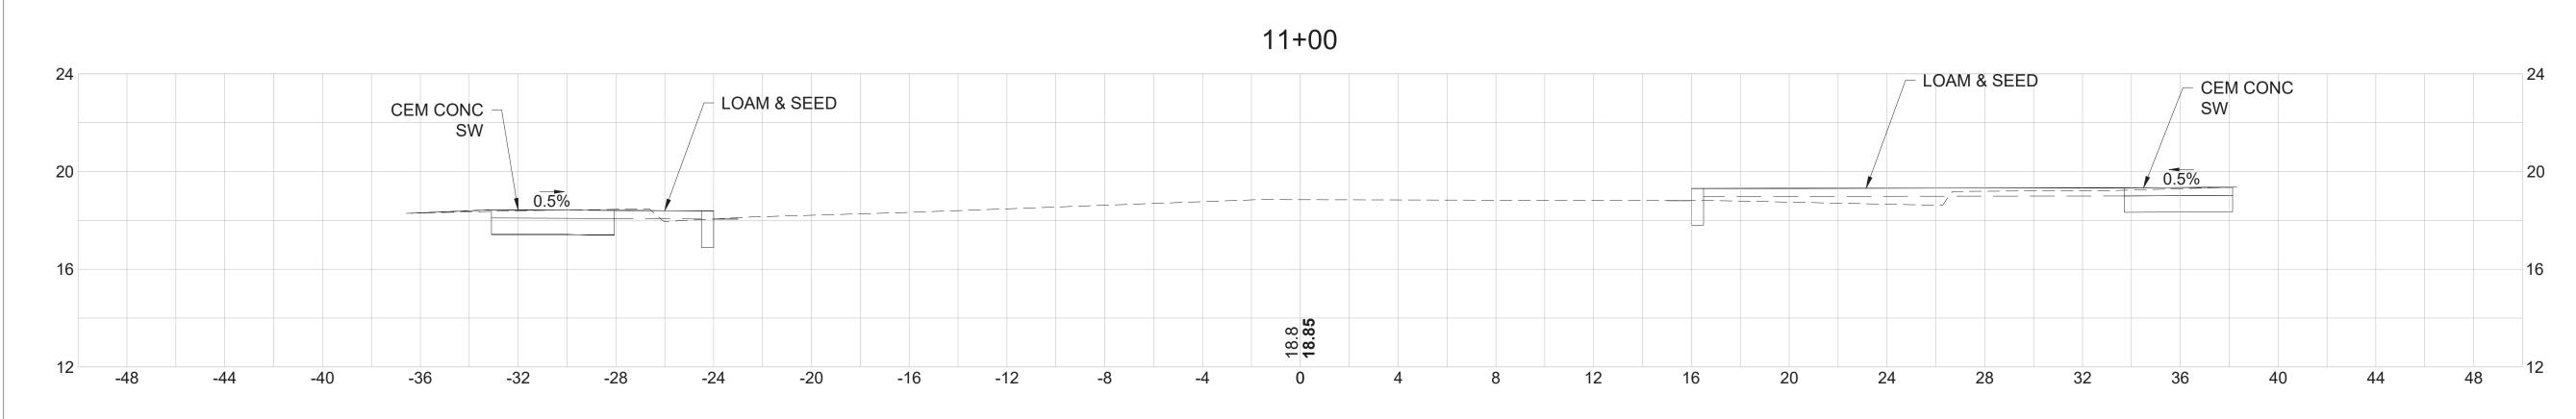13+25







FINAL DESIGN

PROJECT NO.

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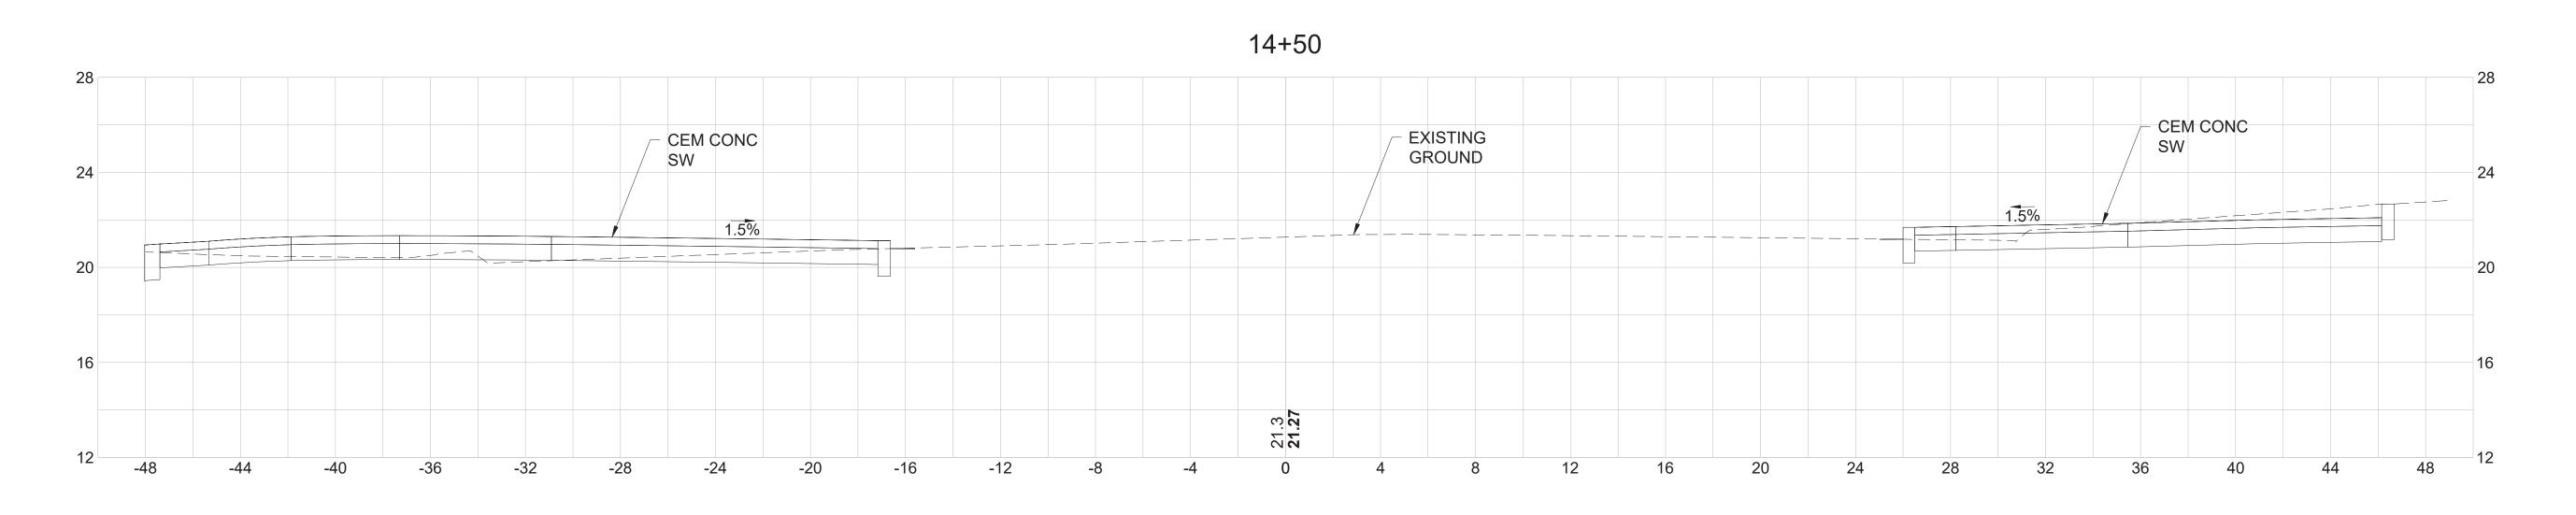
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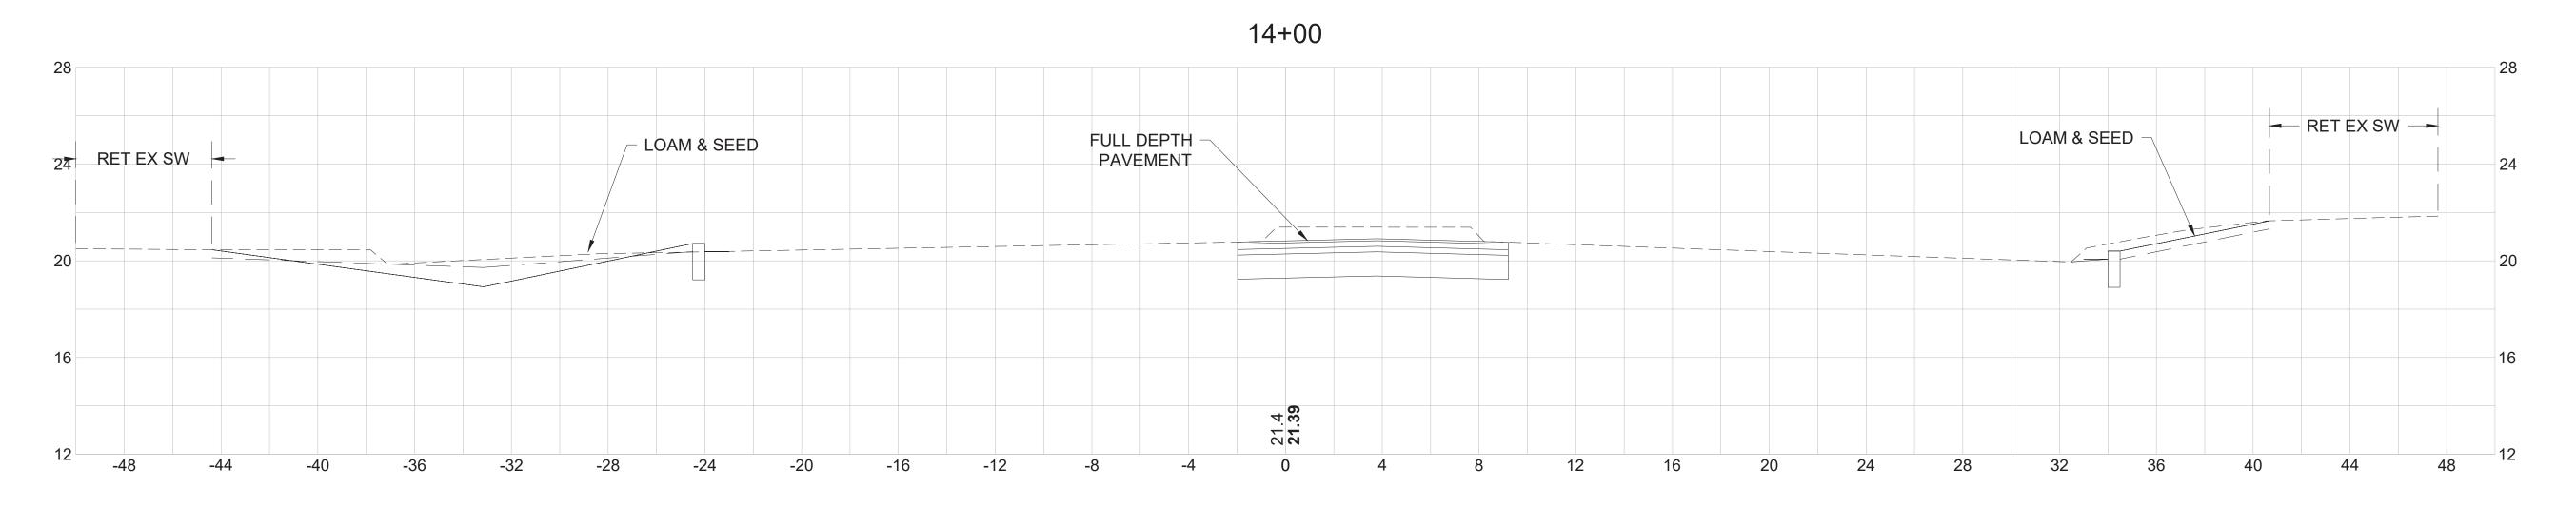


MCCALL MIDDLE SCHOOL
TRAFFIC IMPROVEMENT PROJECT

		60139
	DATE	
		3/18/2020
MYSTIC VALLEY PARKWAY	DRAWING NO.	
CRITICAL CROSS SECTIONS		CS.03
	SHEET NO.	
		30 OE 30

MYSTIC VALLEY PARKWAY






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TRAFFIC IMPROVEMENT PROJEC

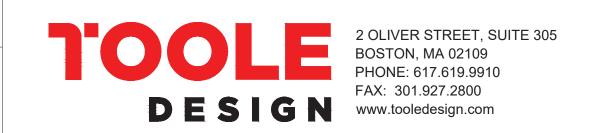	PROJECT NO.	
		60139
	DATE	
		3/18/2020
MYSTIC VALLEY PARKWAY	DRAWING NO.	
CRITICAL CROSS SECTIONS		CS.04
	SHEET NO.	
		39 OF 39